

# MONTEFIORE HEALTH SYSTEM NYACK CAMPUS SITE PLAN DRAWING SET PLANNING BOARD SUBMISSION

LAST REVISED: 06.13.2025


### DRAINAGE & UTILITY IMPROVEMENTS

160 NORTH MIDLAND AVENUE **NYACK, NY 10960** 

**SECTION: 66.21** 

TAX LOT INFO

LOTs: 74, 74.1 & 74.2

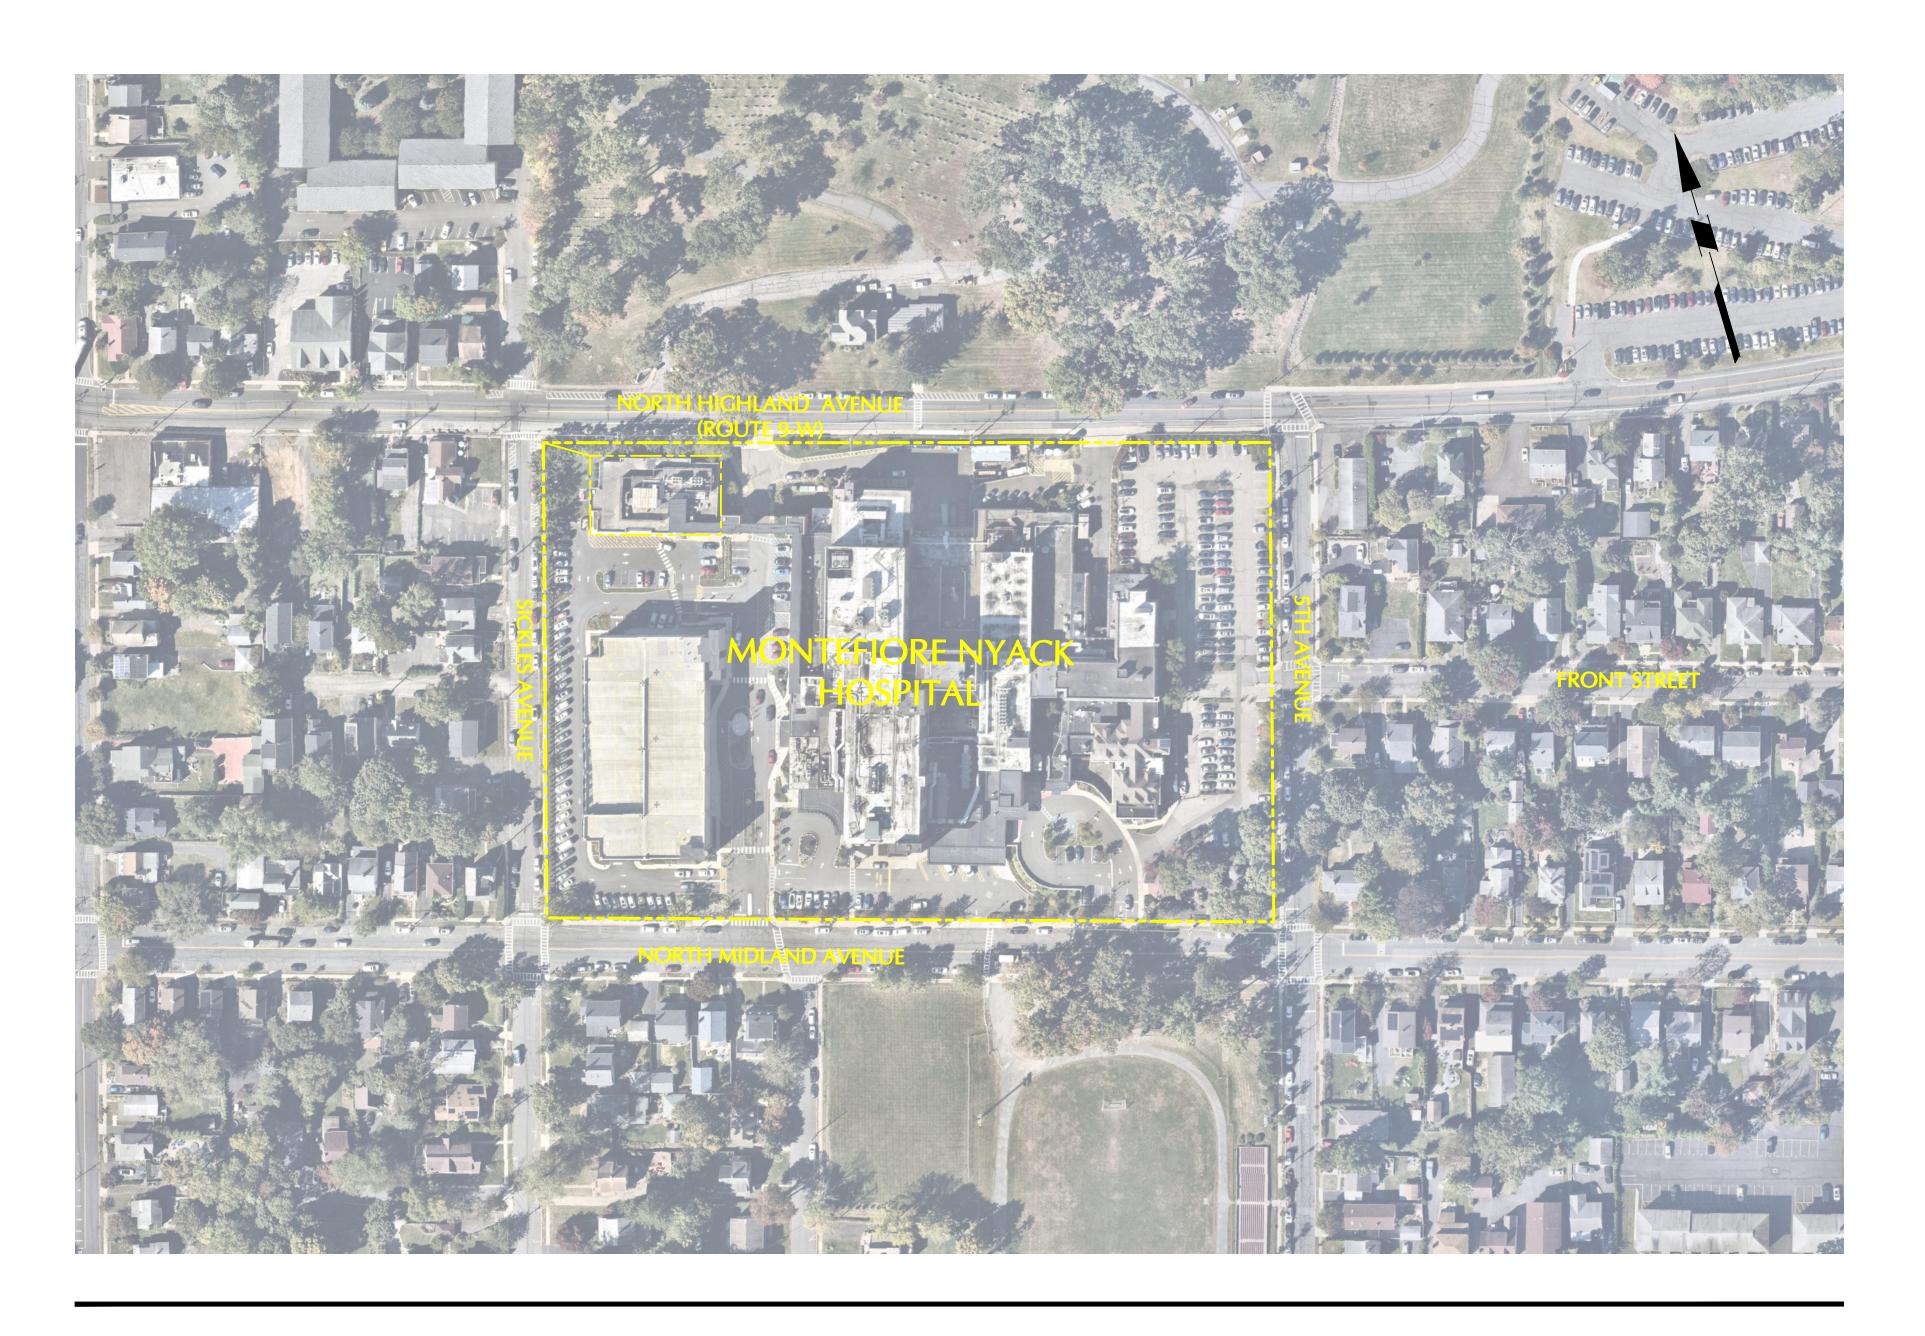

## LOCATION MAP

SCALE: 1'' = 100'

#### **OWNER:**

MONTEFIORE HEALTH SYSTEM NYACK CAMPUS **160 NORTH MIDLAND AVENUE NYACK, NY 10960** 

PROJECT CONTACTS

#### ARCHITECT:


POMARICO DESIGN STUDIO ARCHITECTURE, PLLC 19 FRONT STREET **NEWBURGH, NY 12550** (845) 561-0448


#### **CIVIL ENGINEER & SURVEYOR:**


LANGAN ENGINEERING, ENVIRONMENTAL, SURVEYING, LANDSCAPE ARCHITECTURE AND GEOLOGY, D.P.C. 300 KIMBALL DRIVE, 4TH FLOOR PARSIPPANY, NJ 07054 (973) 560-4900


### INDEX OF DRAWINGS


| LANGAN |  | DATE       | LAST REVISED |
|--------|--|------------|--------------|
| CS001  | COVER SHEET                                  | 01.29.2025 | 06.13.2025   |
| VT101  | BOUNDARY & PARTIAL TOPOGRAPHIC SURVEY        | 08.13.2024 | -            |
| VT102  | BOUNDARY & PARTIAL TOPOGRAPHIC SURVEY        | 08.13.2024 | -            |
| CS100  | OVERALL SITE PLAN                            | 01.29.2025 | 06.13.2025   |
| CS101  | PARTIAL SITE PLAN                            | 01.29.2025 | 06.13.2025   |
| CS102  | PARTIAL SITE PLAN                            | 01.29.2025 | 06.13.2025   |
| CG101  | PARTIAL GRADING, DRAINAGE, & UTILITY PLAN    | 01.29.2025 | 06.13.2025   |
| CG102  | PARTIAL GRADING, DRAINAGE, & UTILITY PLAN    | 01.29.2025 | 06.13.2025   |
| CE101  | PARTIAL SOIL EROSION & SEDIMENT CONTROL PLAN | 01.29.2025 | 06.13.2025   |
| CE101  | PARTIAL SOIL EROSION & SEDIMENT CONTROL PLAN | 01.29.2025 | 06.13.2025   |
| CS501  | DETAILS                                      | 01.29.2025 | 06.13.2025   |
| CS502  | DETAILS II                                   | 01.29.2025 | 05.16.2025   |

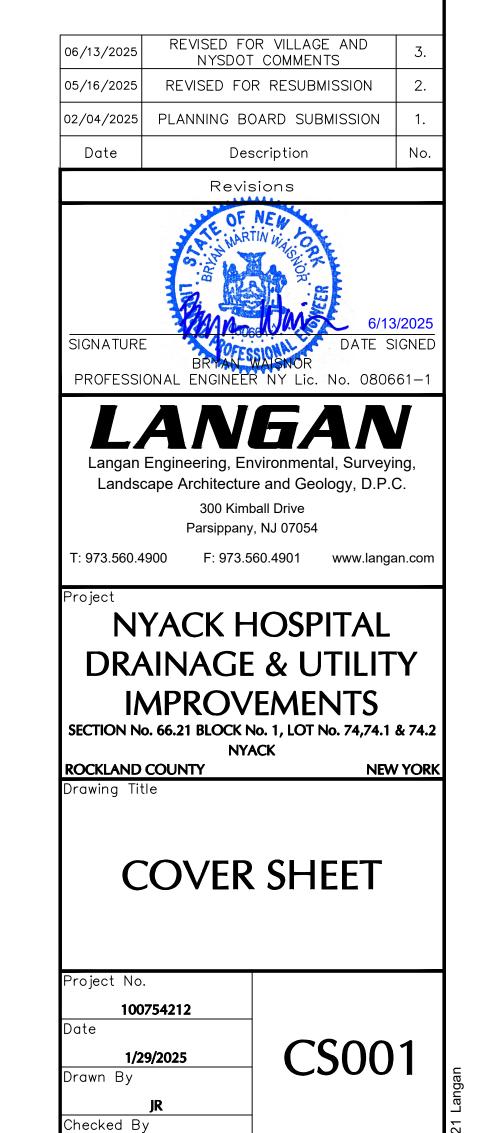


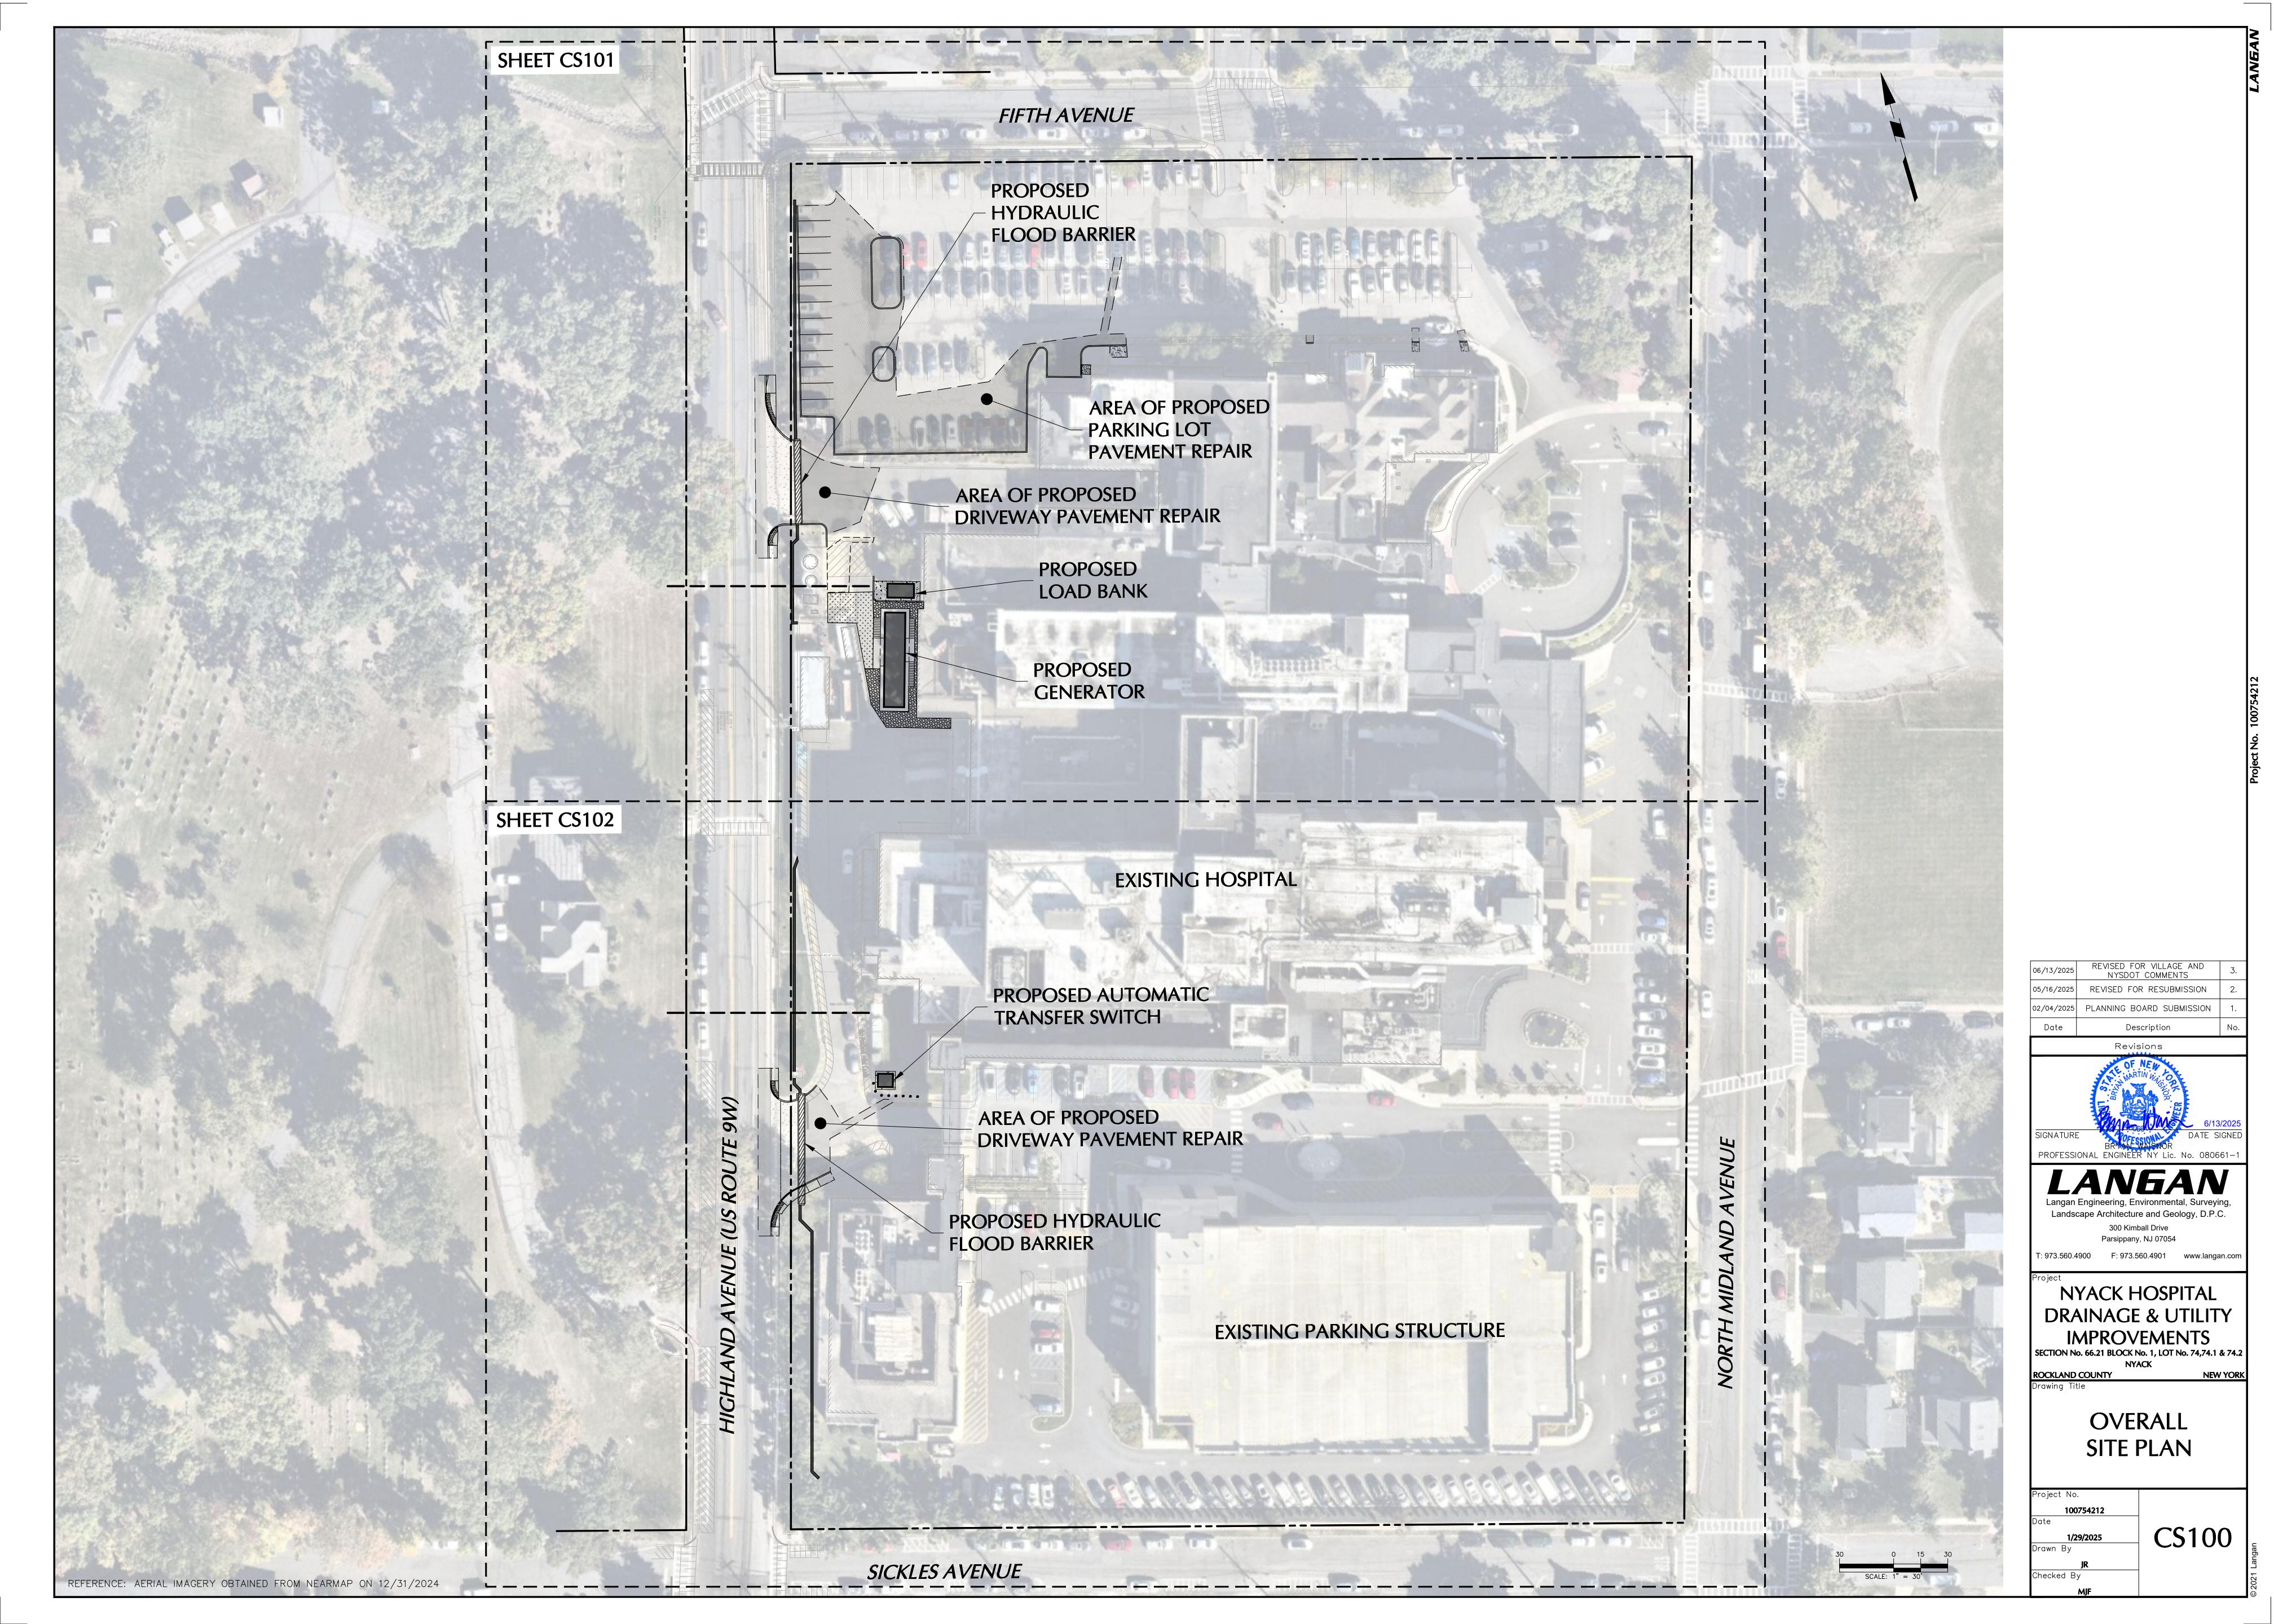


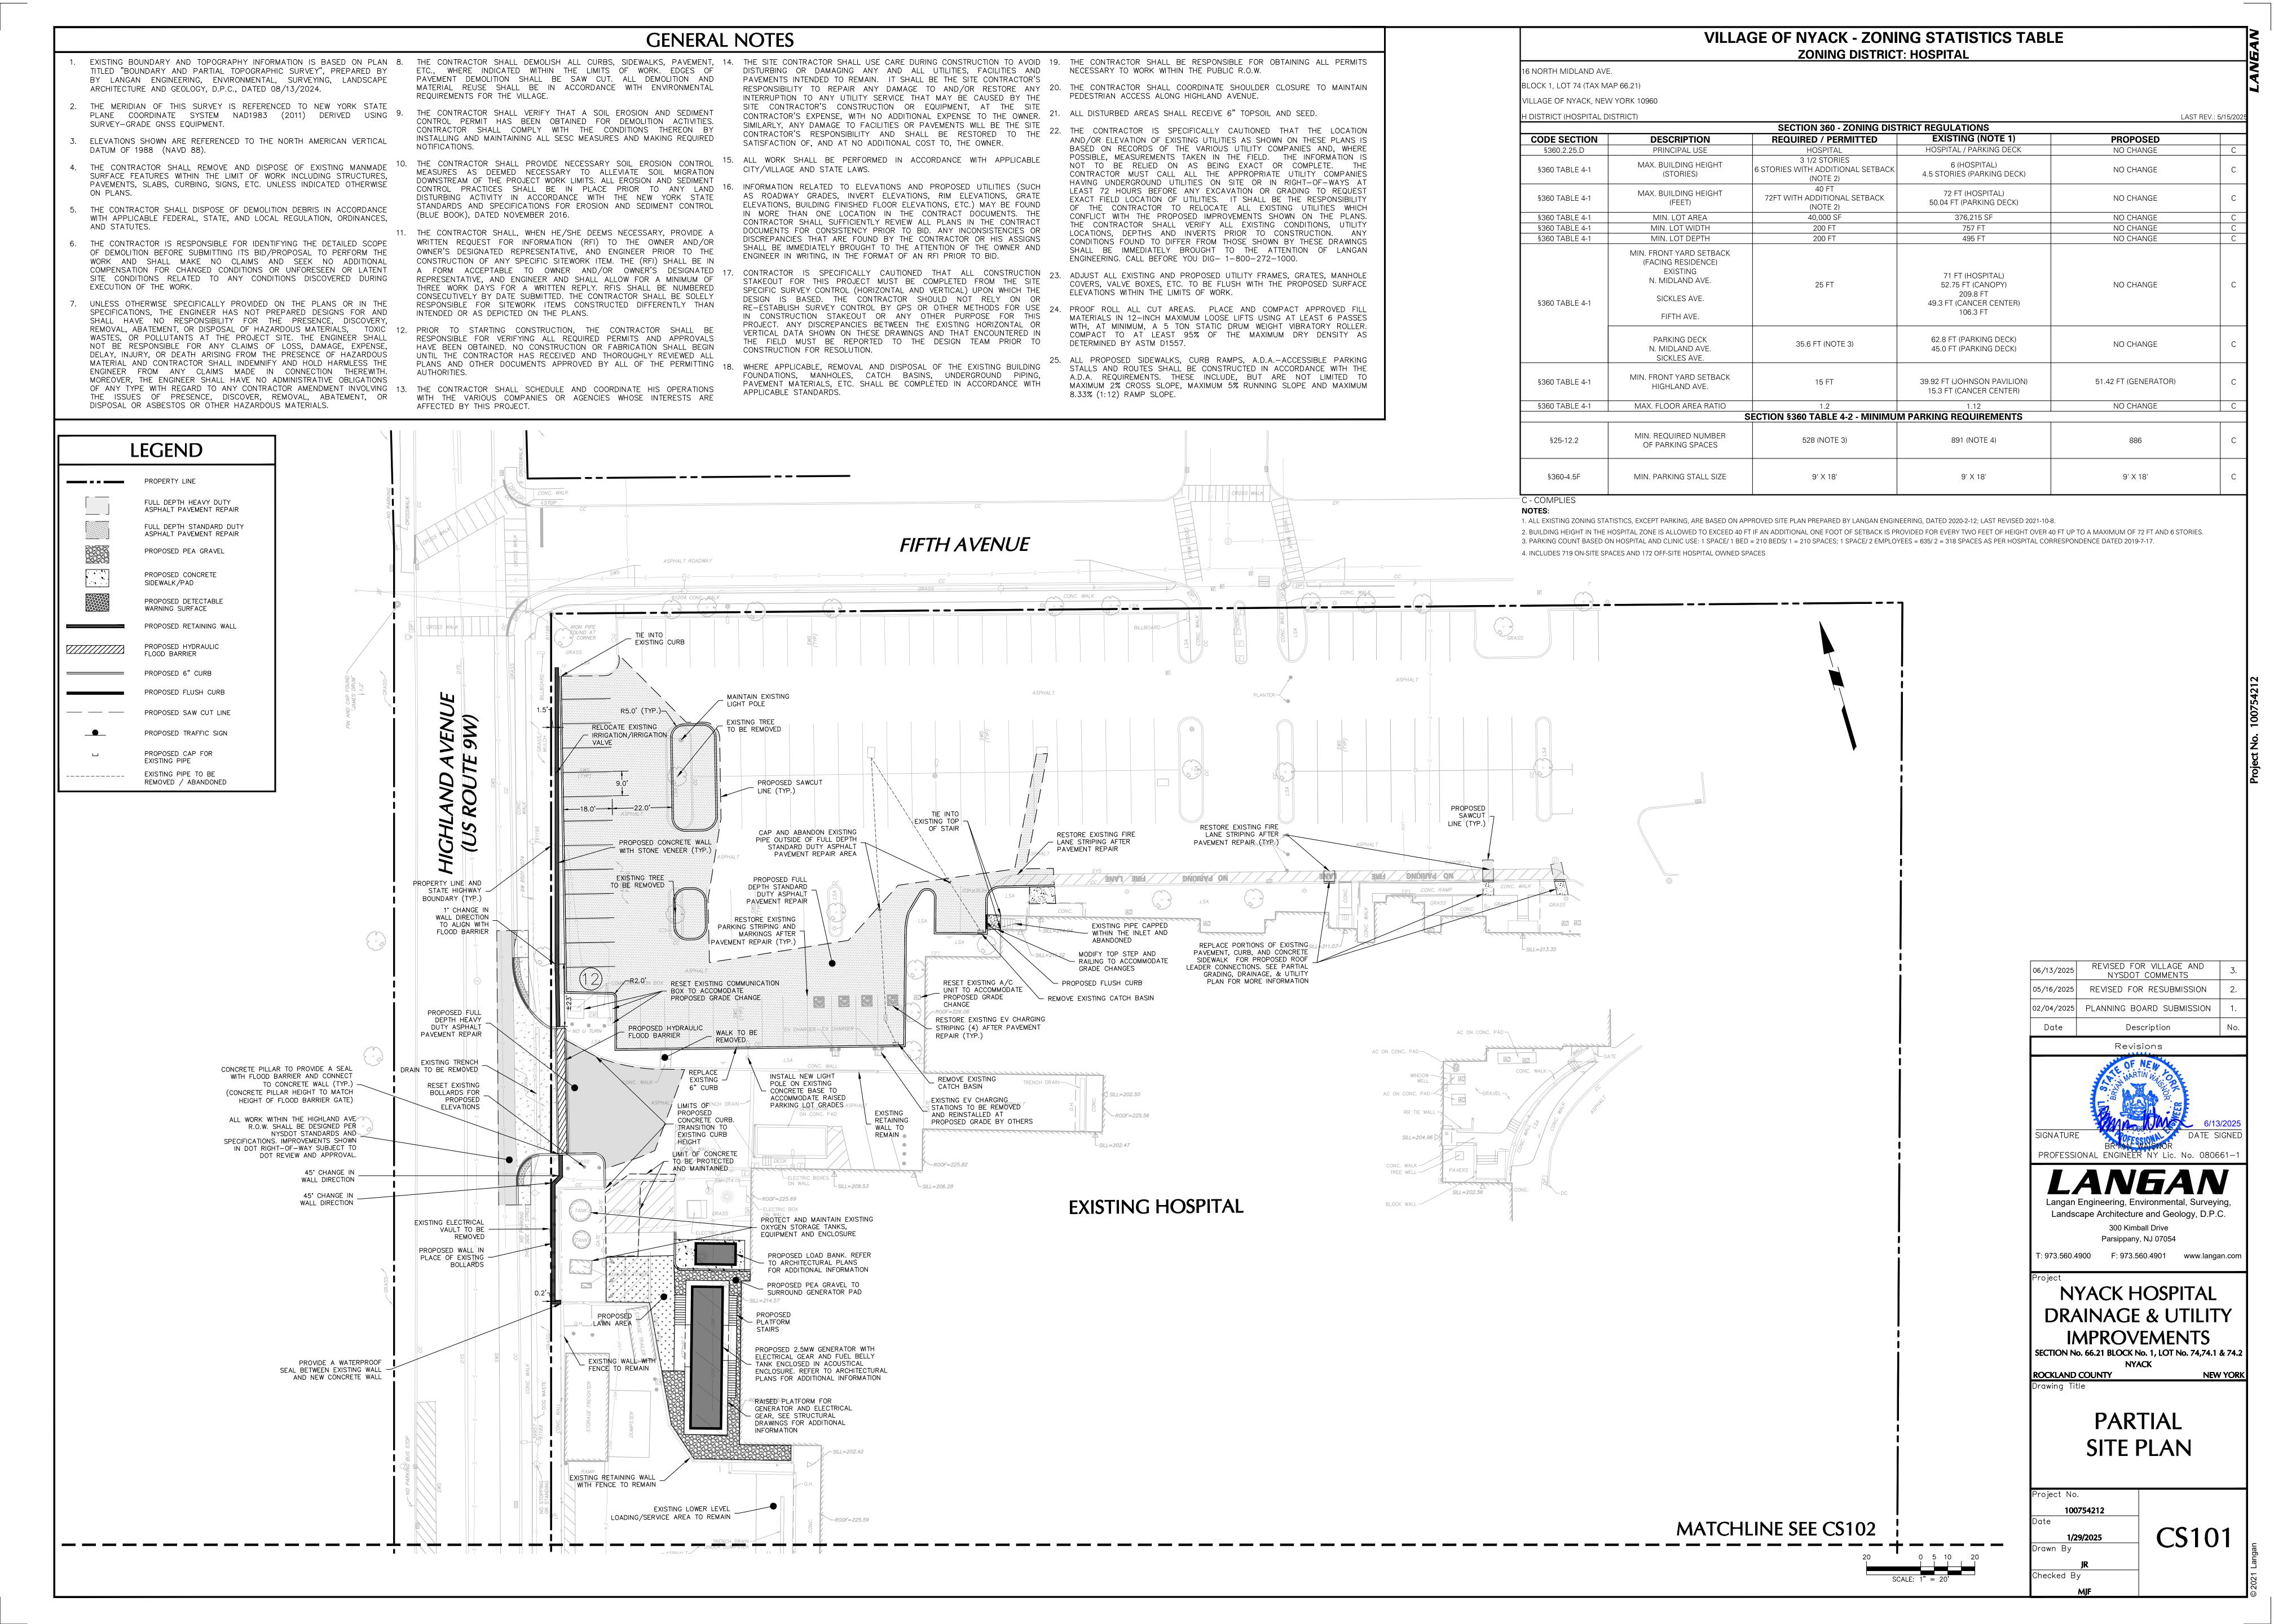


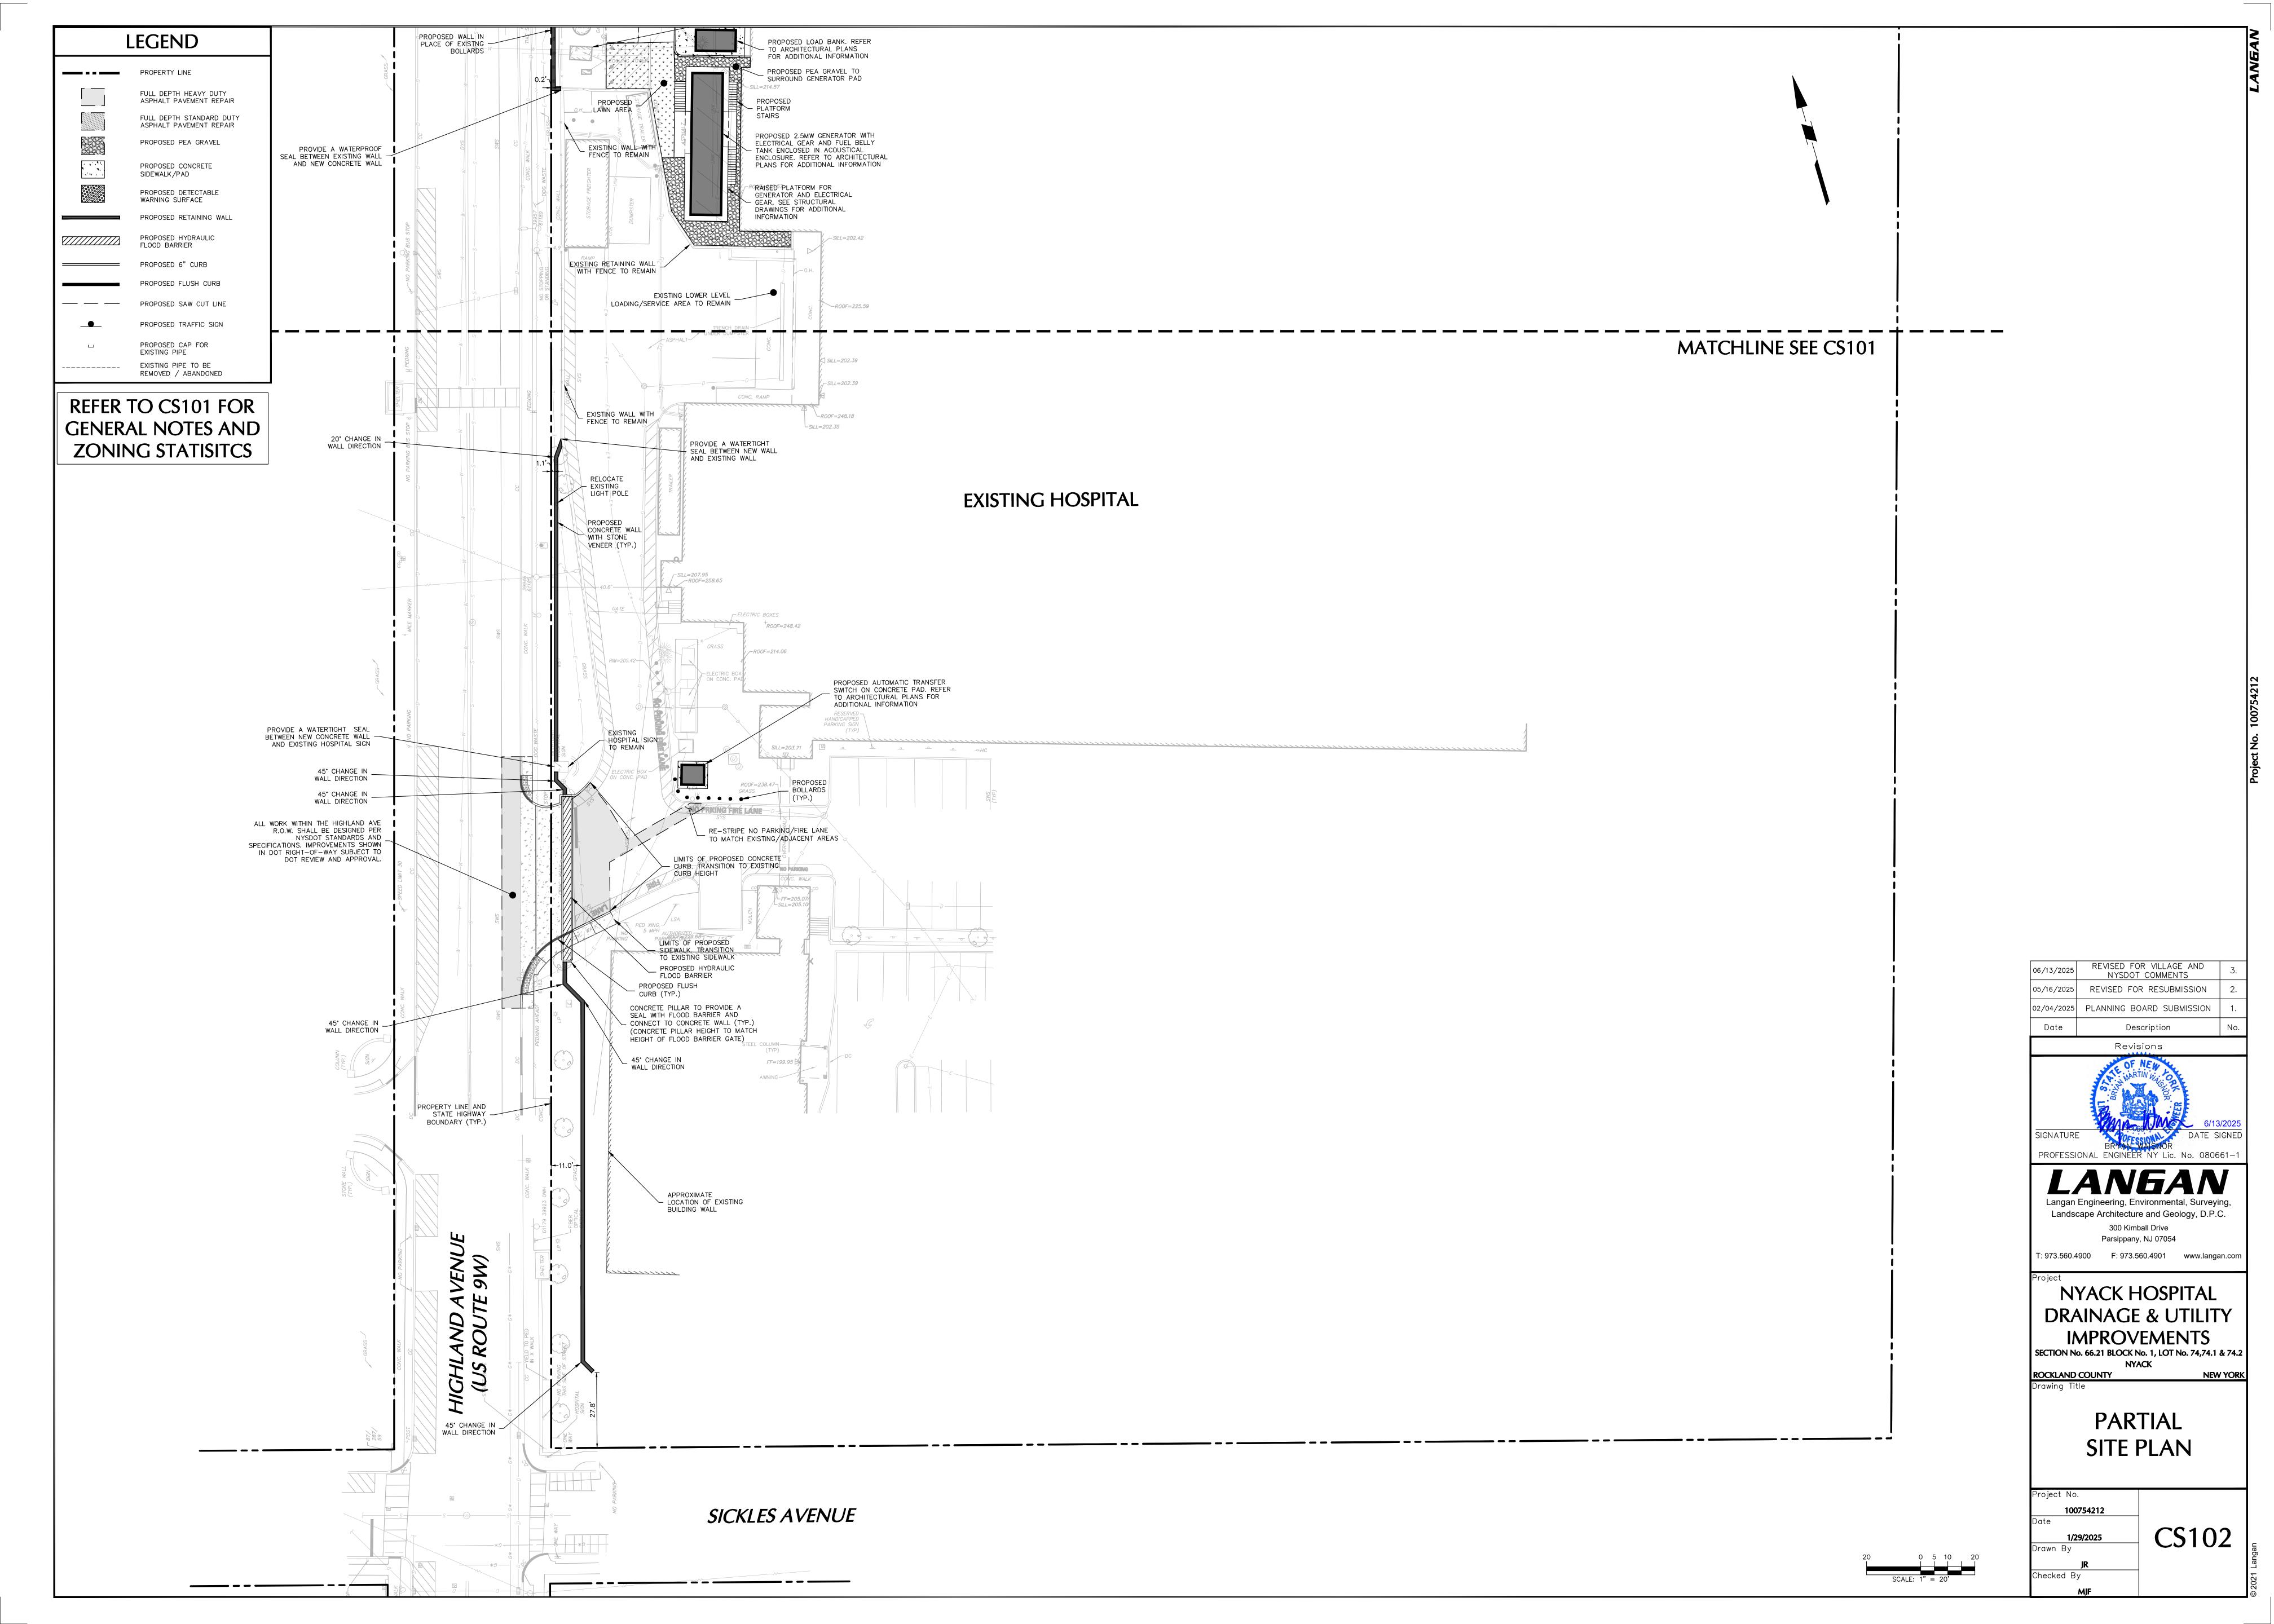

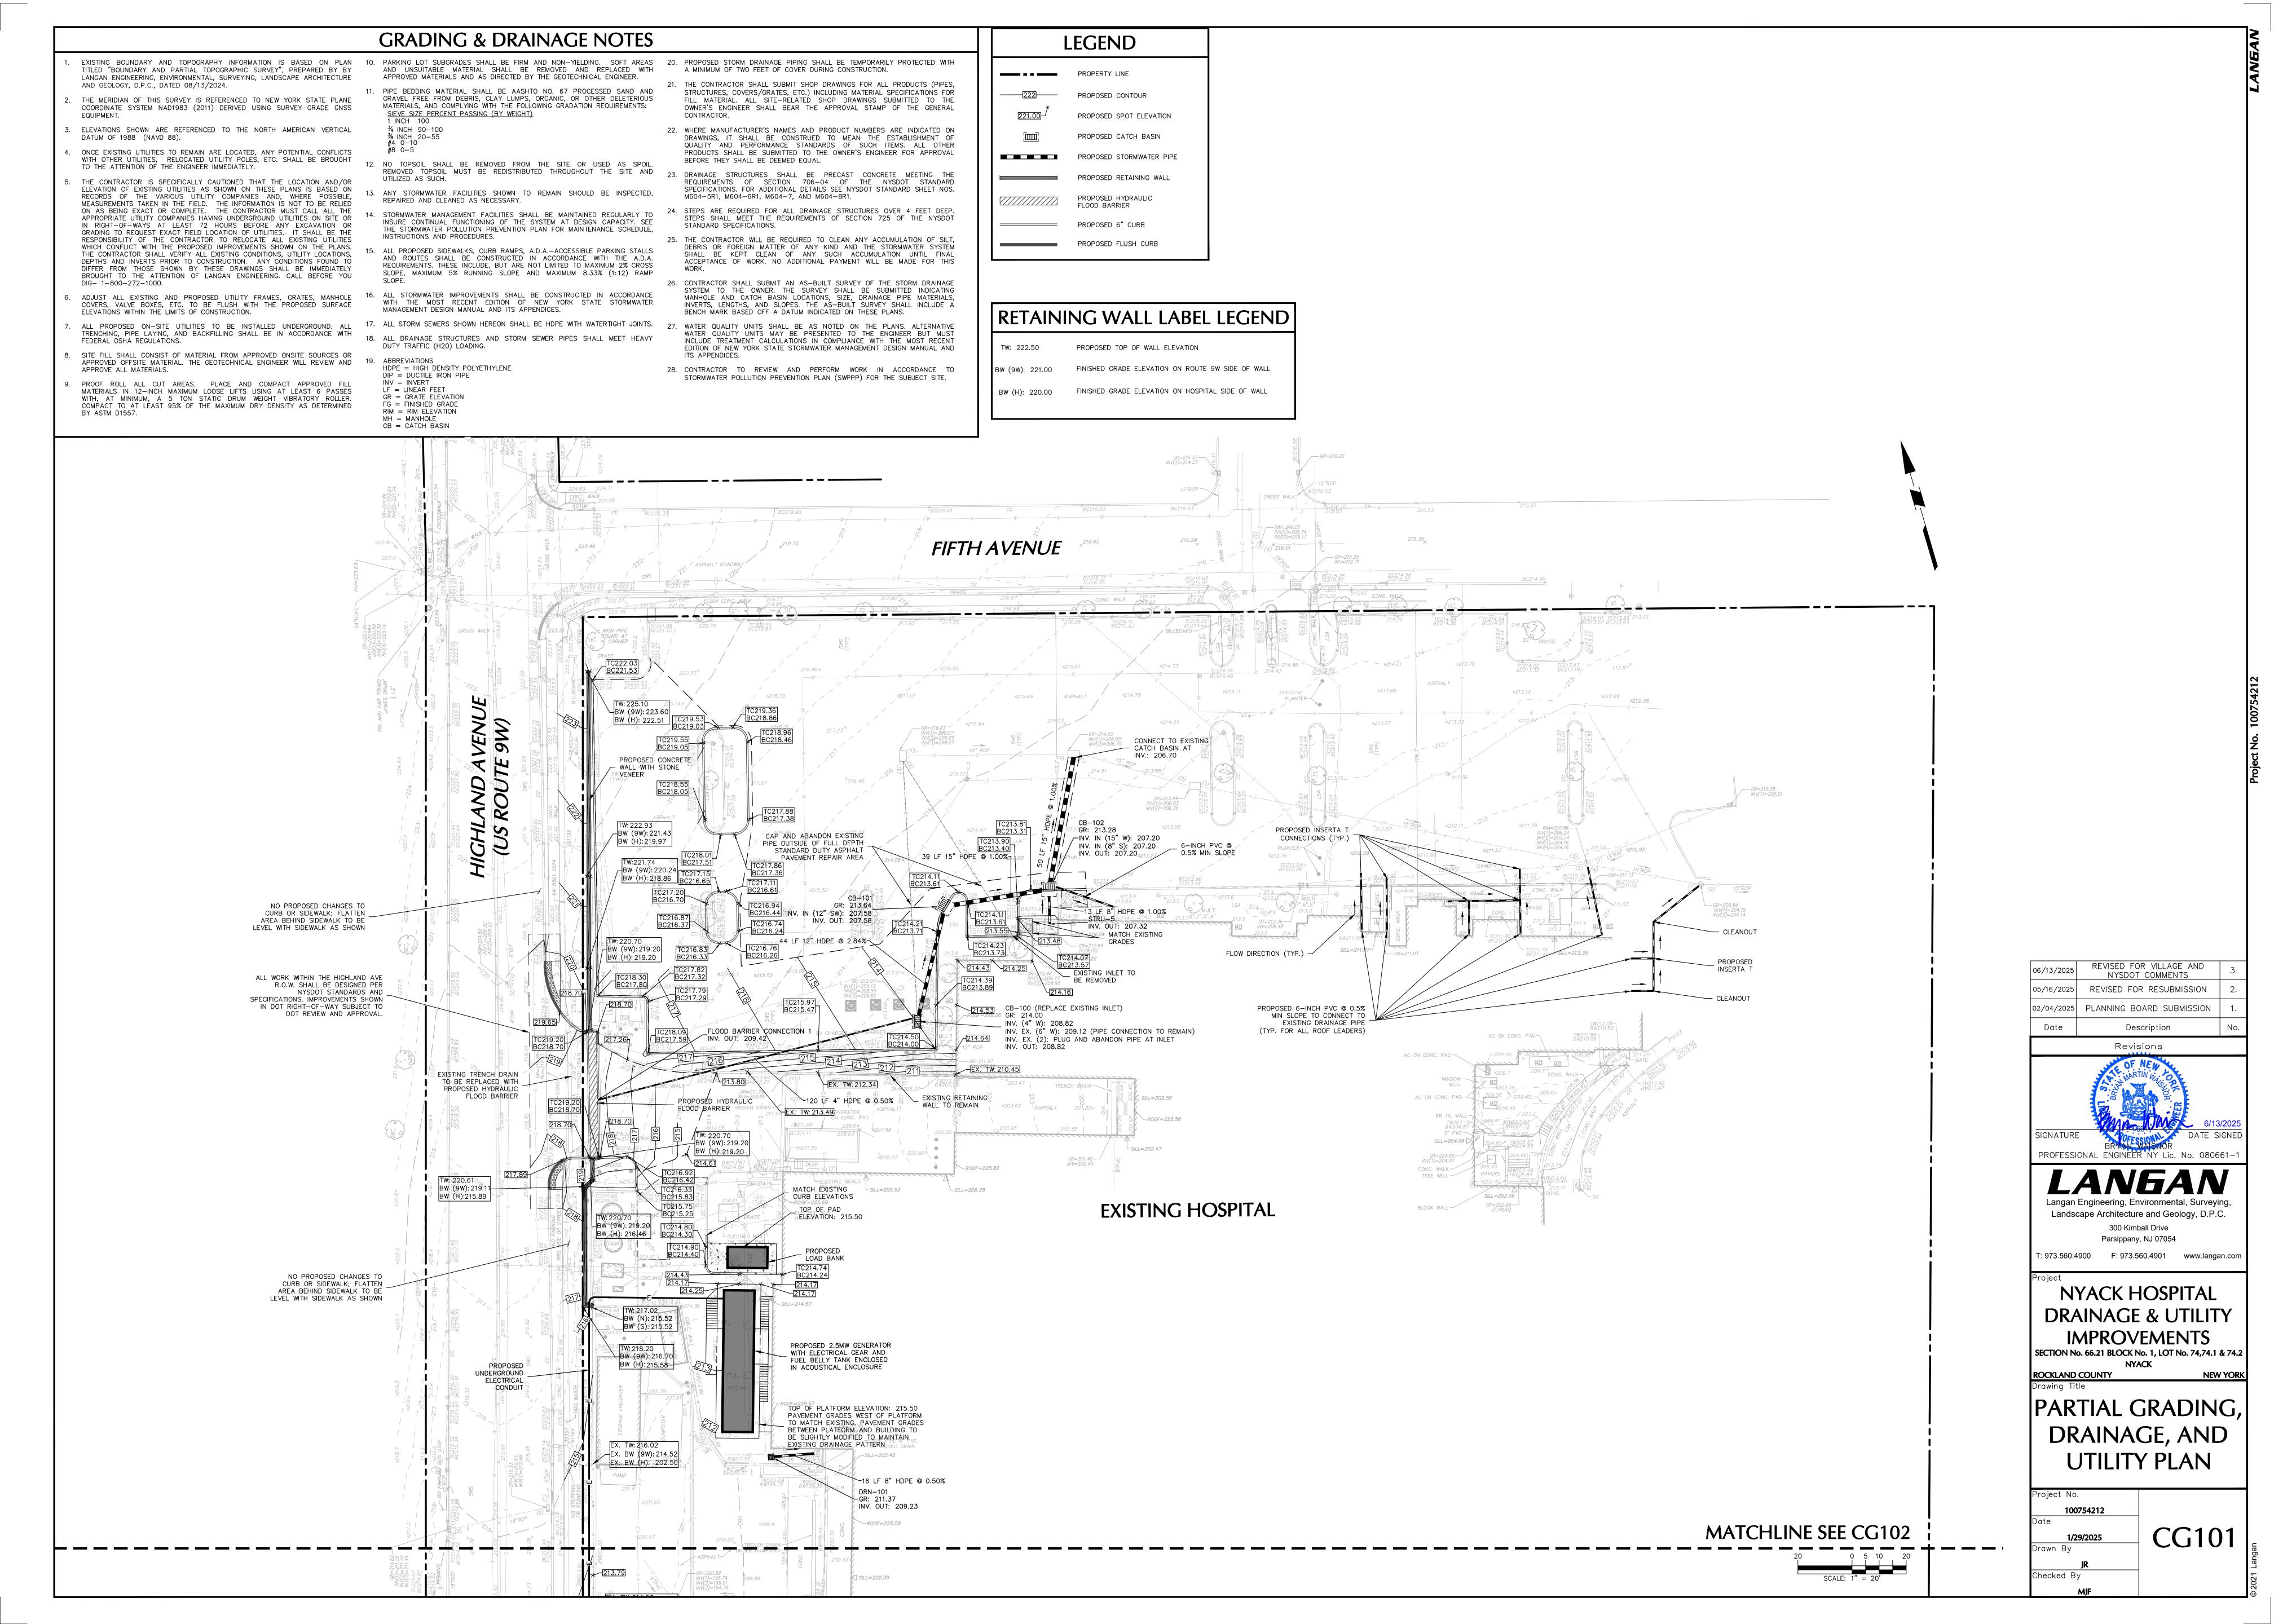


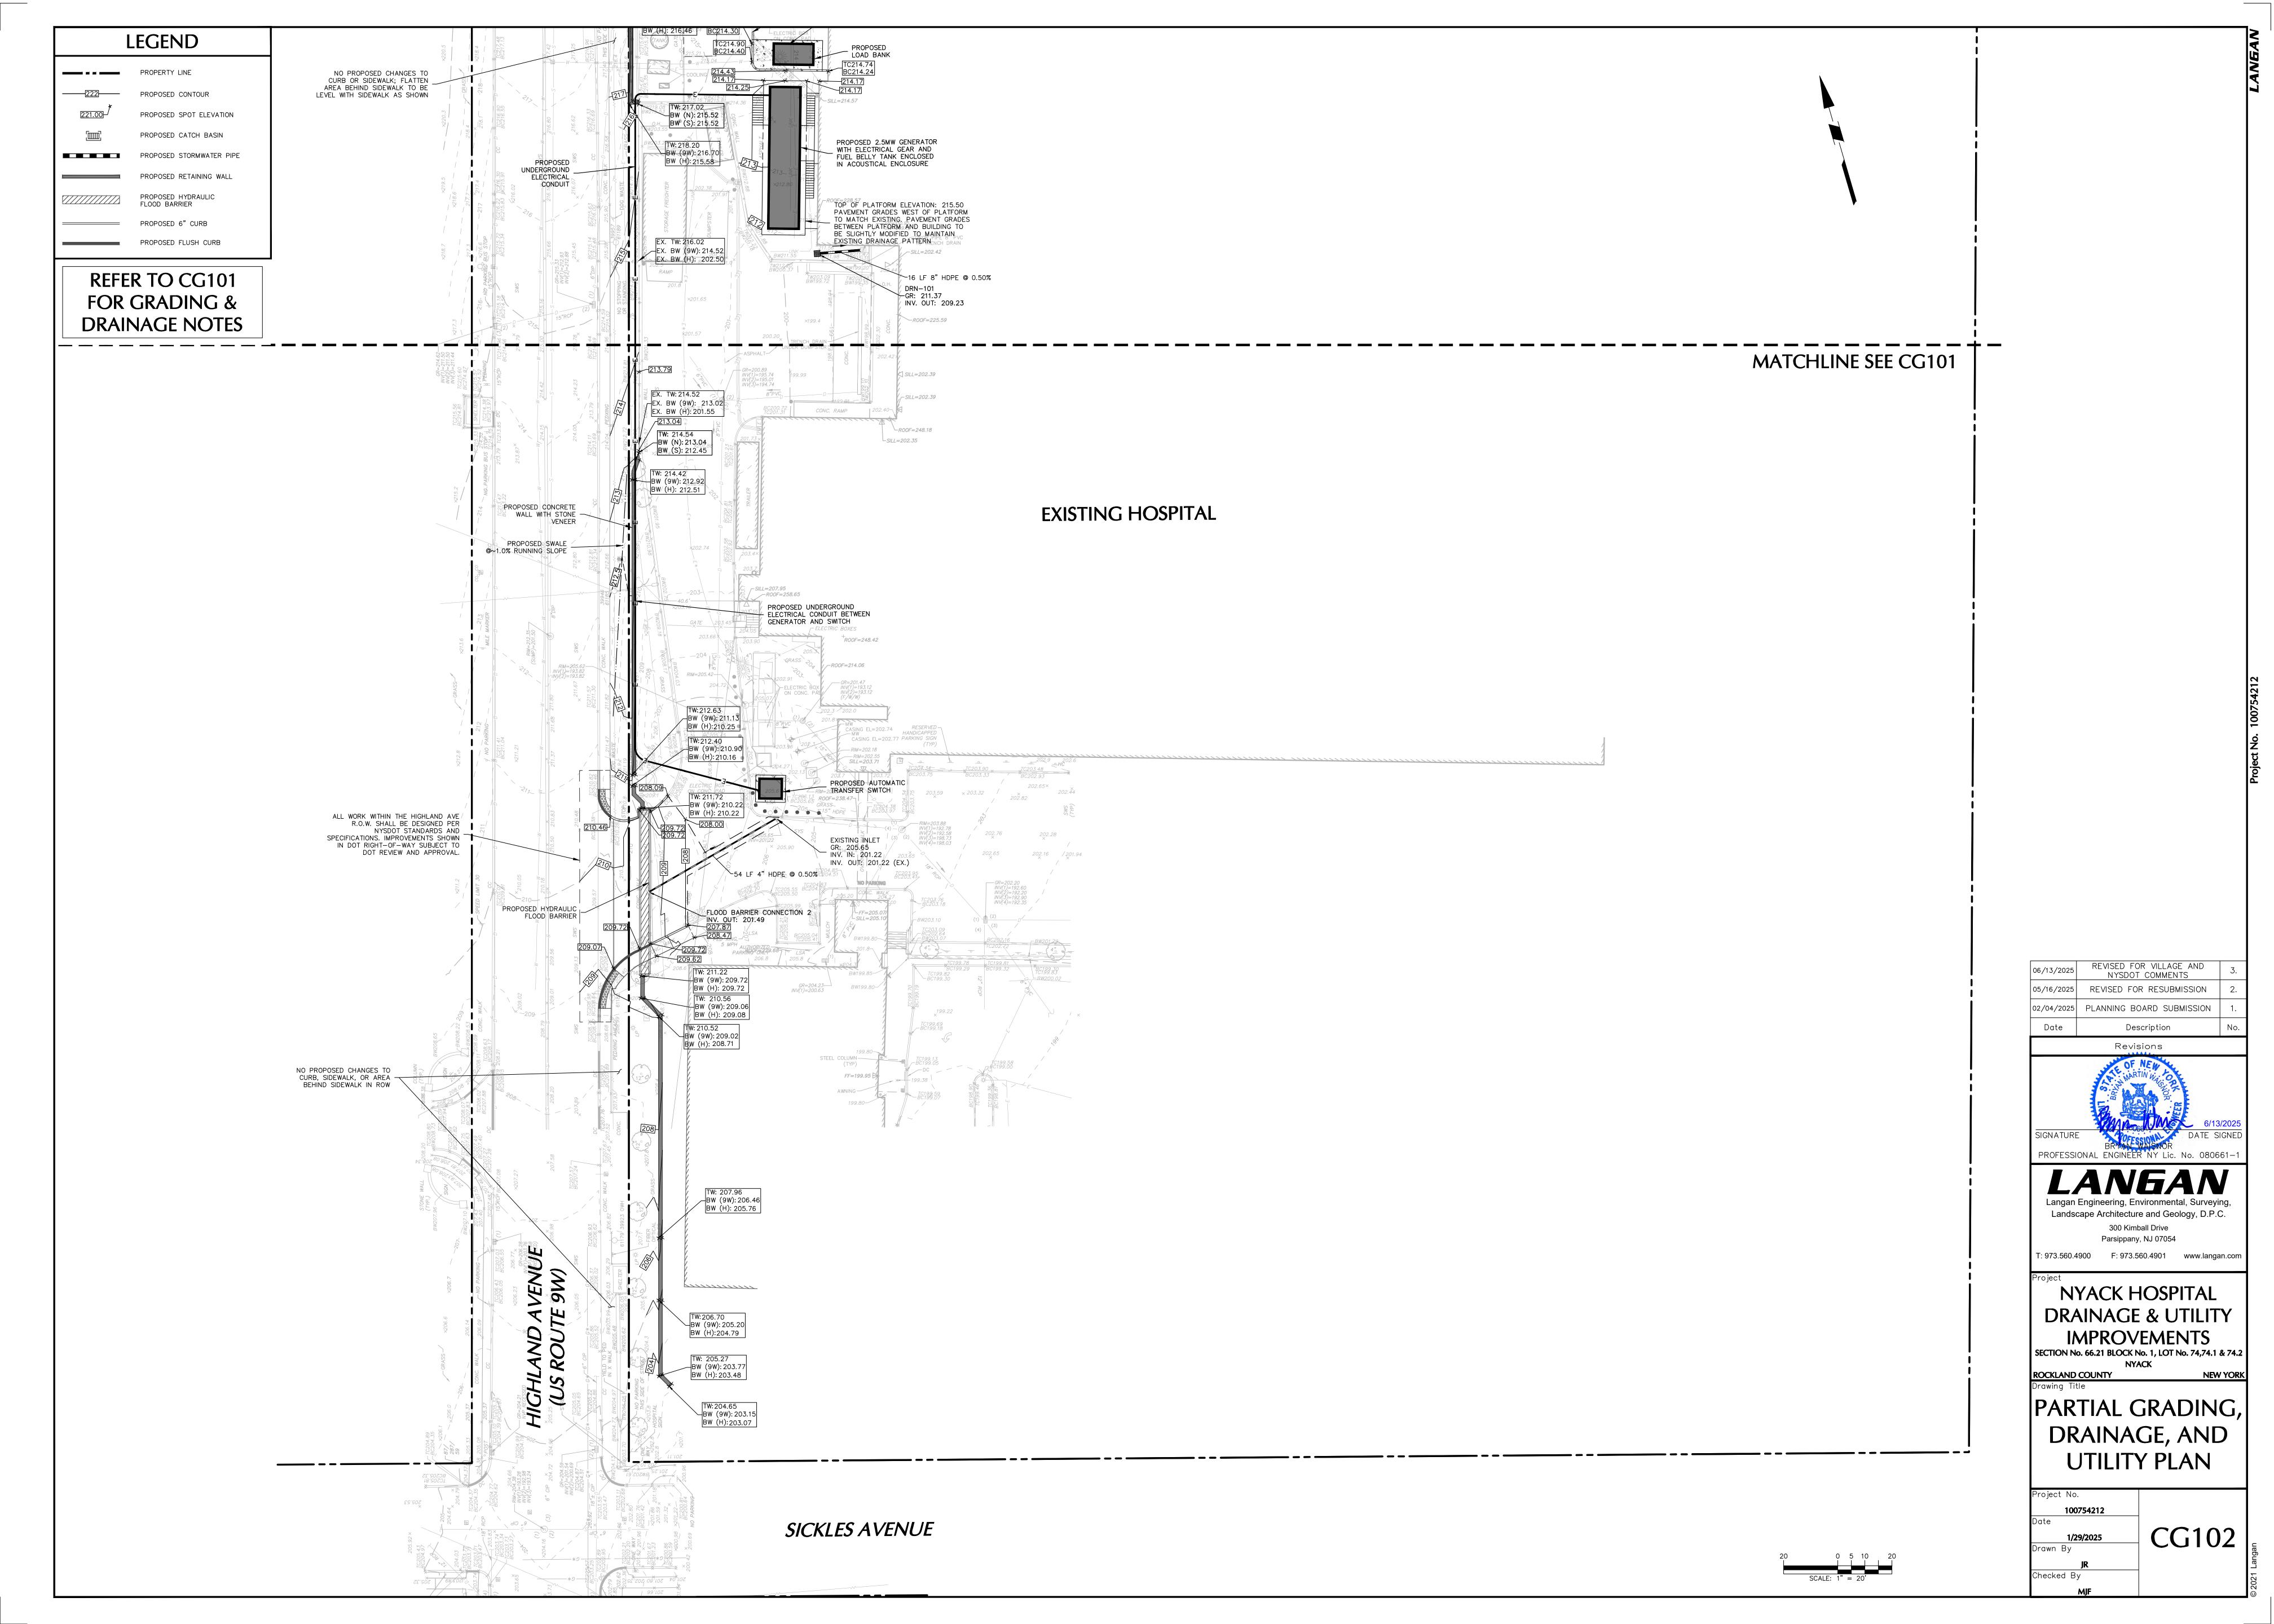

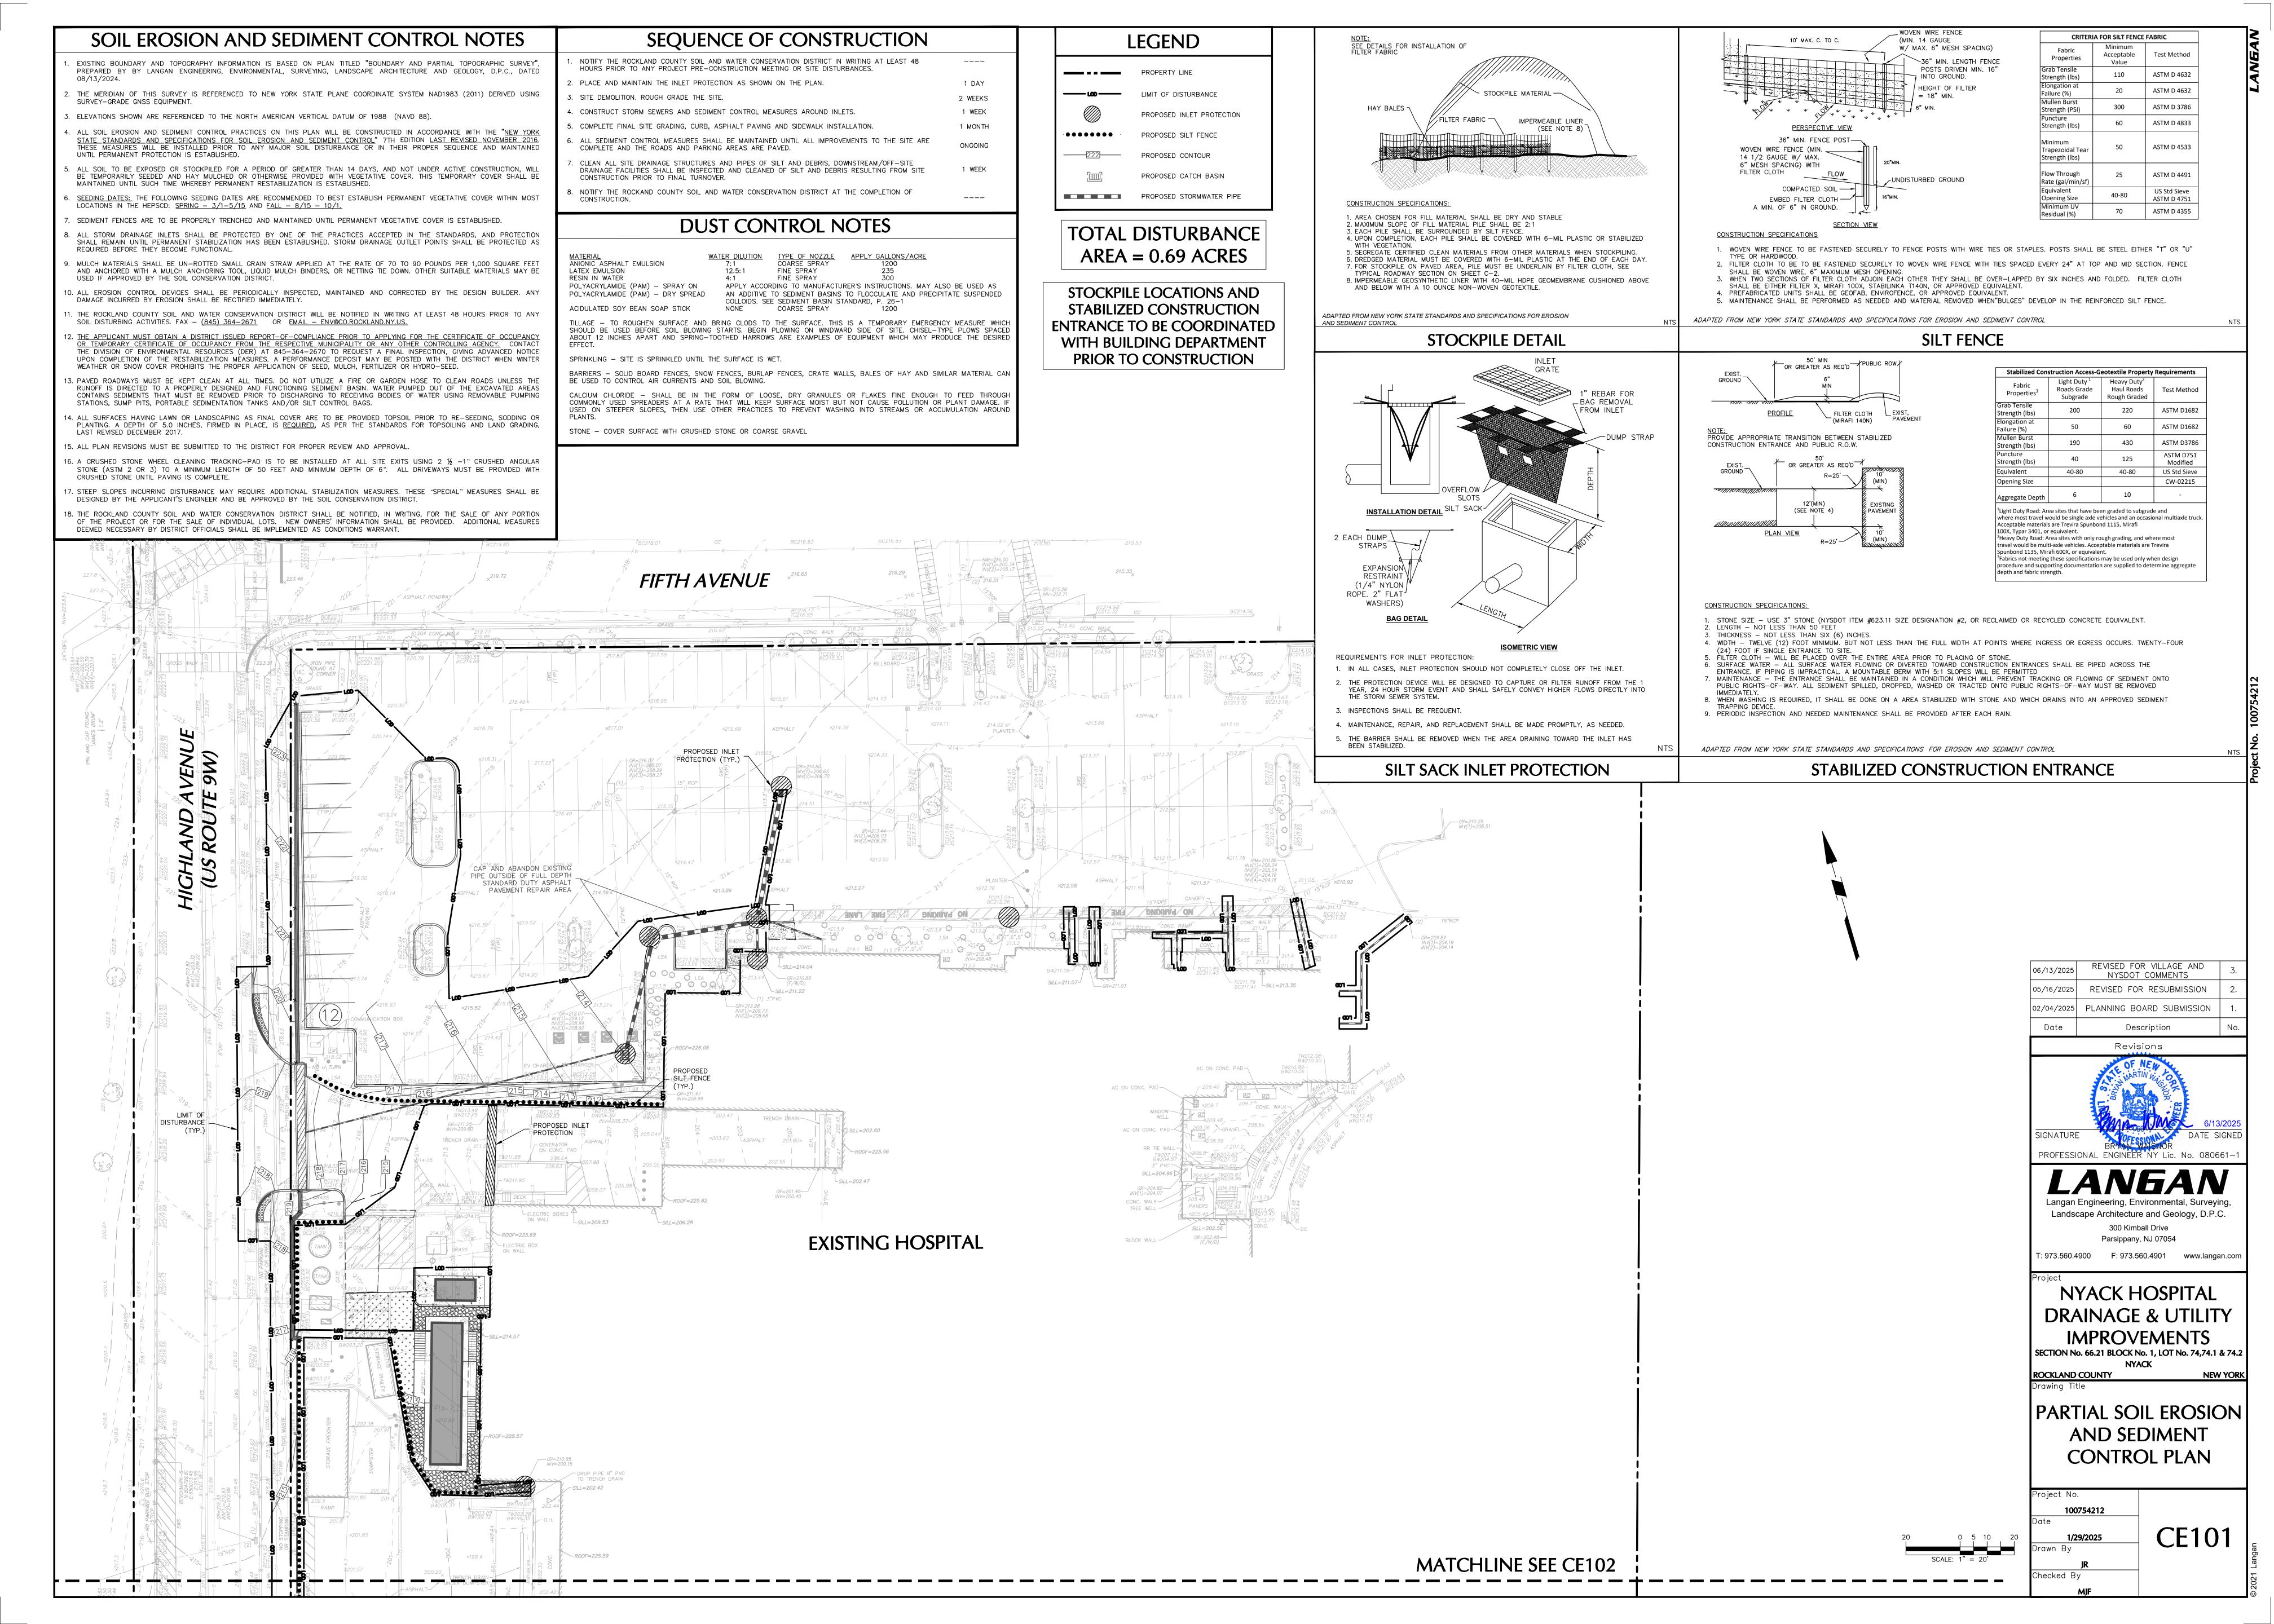


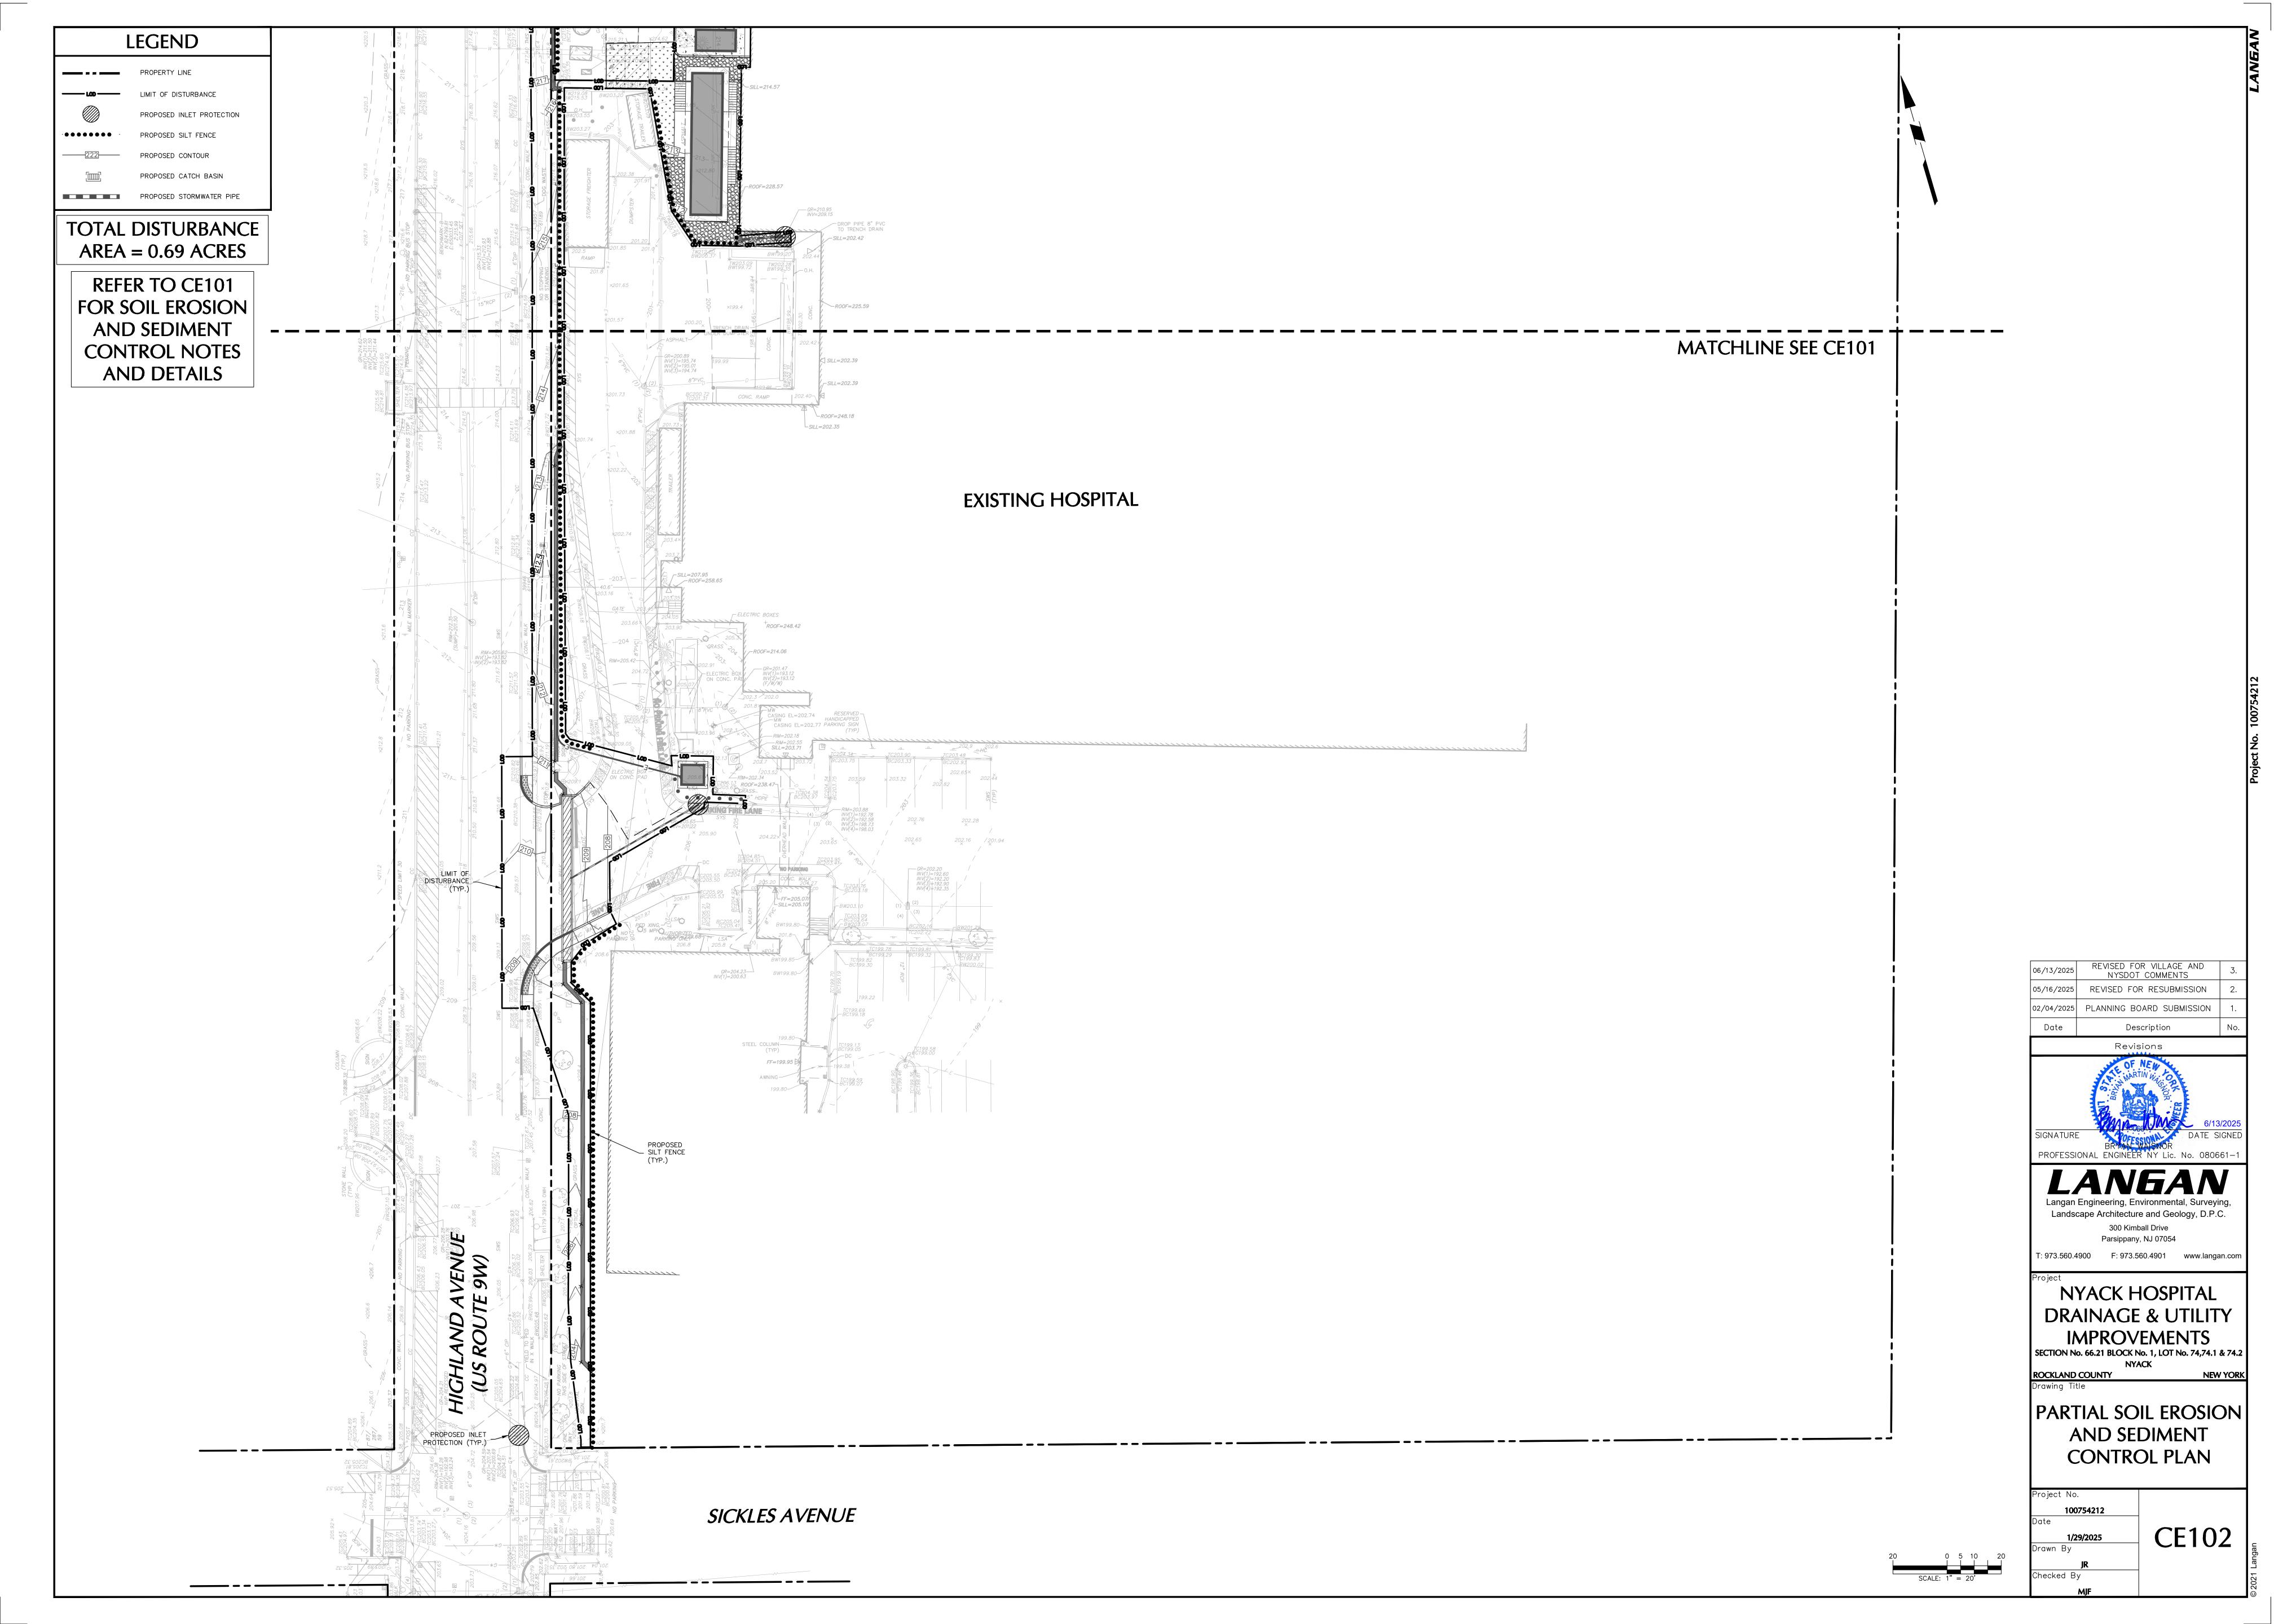



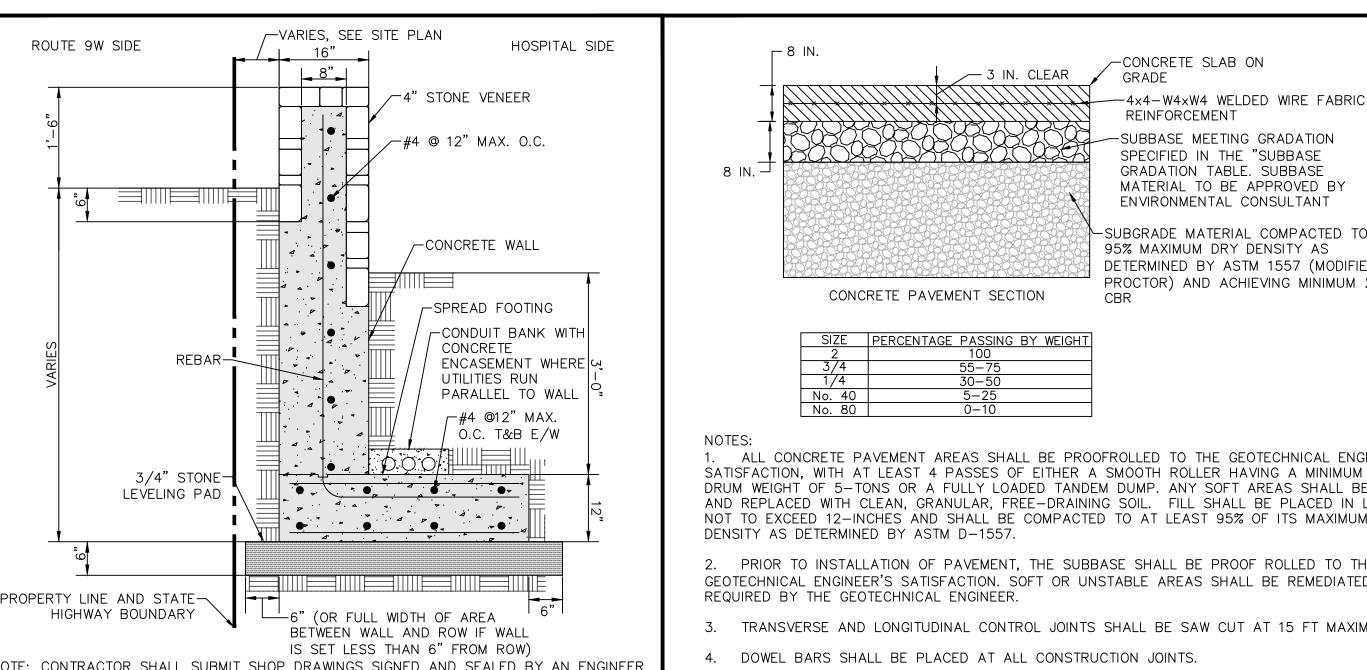

SURFACE COURSE | BINDER COURSE | BASE **ASPHALT SECTION** 'A' (9.5M64) 'B' (19M64) **CAR PARKING LOT** 6 INCHES 2.5 INCHES (STANDARD DUTY) MAIN ACCESS DRIVE 3.0 INCHES 8 INCHES 1.5 INCHES (HEAVY DUTY)

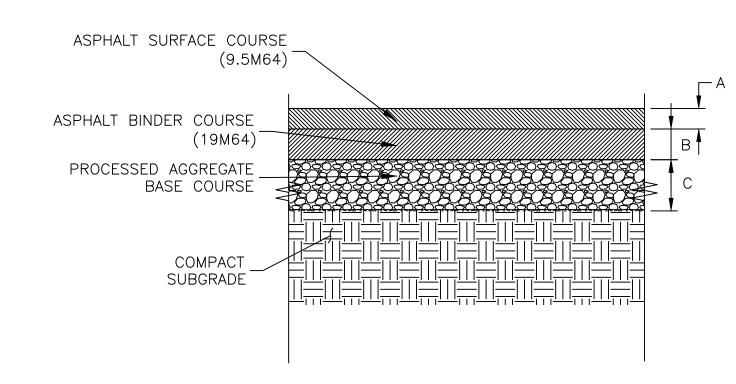


NOTES:

- 1. THE ABOVE PAVEMENT SECTIONS ARE SUBJECT TO REVIEW AND CONFIRMATION BY THE PROJECT GEOTECHNICAL ENGINEER. 2. PRIOR TO PLACEMENT OF SUBBASE, THE SUBGRADE SHALL BE PROOF ROLLED TO THE GEOTECHNICAL ENGINEER'S SATISFACTION. SOFT OR UNSTABLE AREAS SHALL BE REMEDIATED AS REQUIRED BY THE GEOTECHNICAL ENGINEER.
- 3. PRIOR TO ANY PAVING ACTIVITIES, THE SUBBASE SHALL BE PROOF ROLLED TO THE GEOTECHNICAL ENGINEER'S SATISFACTION. SOFT OR UNSTABLE AREAS SHALL BE REMEDIATED AS REQUIRED BY THE GEOTECHNICAL ENGINEER. 4. PAVING BASE COURSE SHALL BE CONSTRUCTED IN LAYERS NOT LESS THAN 2
- INCHES AND NOT MORE THAN 4 INCHES THICK PER LIFT. ALL AREAS TO BE PAVED SHALL BE PROOFROLLED TO THE GEOTECHNICAL ENGINEER'S SATISFACTION, WITH AT LEAST 4 PASSES OF EITHER A SMOOTH ROLLER HAVING A MINIMUM STATIC DRUM WEIGHT OF 5-TONS OR A FULLY LOADED TANDEM DUMP TRUCK. ANY SOFT AREAS SHALL BE REMOVED AND REPLACED WITH CLEAN, GRANULAR, FREE-DRAINING SOIL. FILL SHALL BE PLACED IN LOOSE LIFTS NOT TO EXCEED 12-INCHES AND SHALL BE COMPACTED TO AT LEAST 95% OF ITS MAXIMUM DRY DENSITY AS DETERMINED BY ASTM D-1557.

WHERE NOT OTHERWISE SPECIFIED, ALL WORK TO BE PERFORMED IN ACCORDANCE

NTS

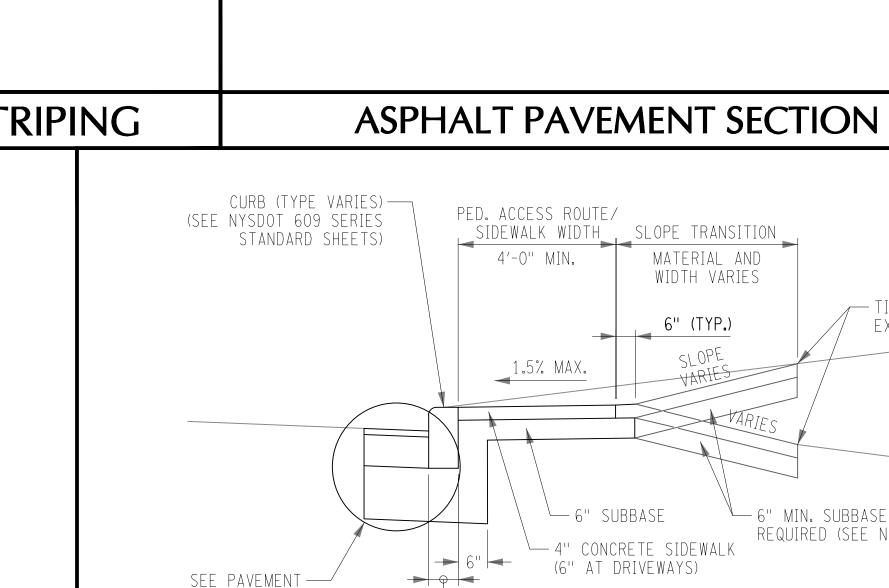

TYPICAL SIDEWALK CROSS SECTION CURBED WITHOUT BUFFER ZONE

TYPICAL SIDEWALK CROSS SECTION



REVISED FOR VILLAGE AND

NYSDOT COMMENTS

REVISED FOR RESUBMISSION

ROCKLAND COUNTY
Drawing Title


DRAINAGE & UTILITY


**IMPROVEMENTS** 

**NEW YORK** 

**DETAILS I** 

CS501 Checked By

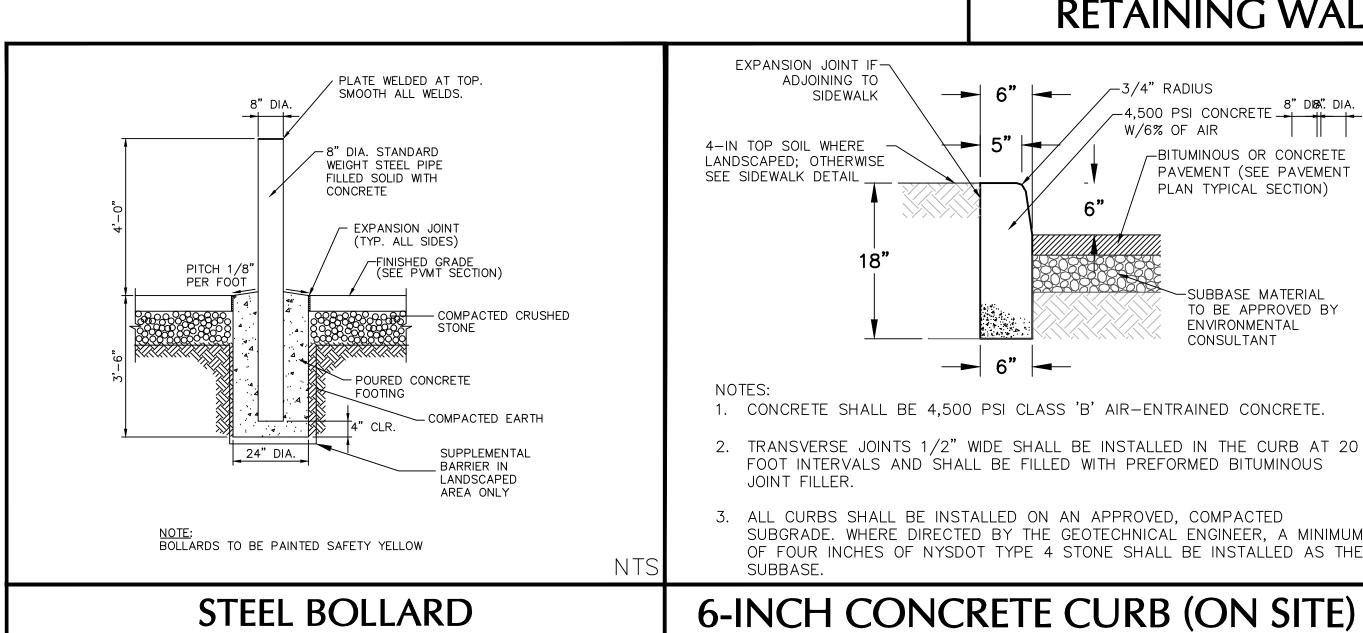

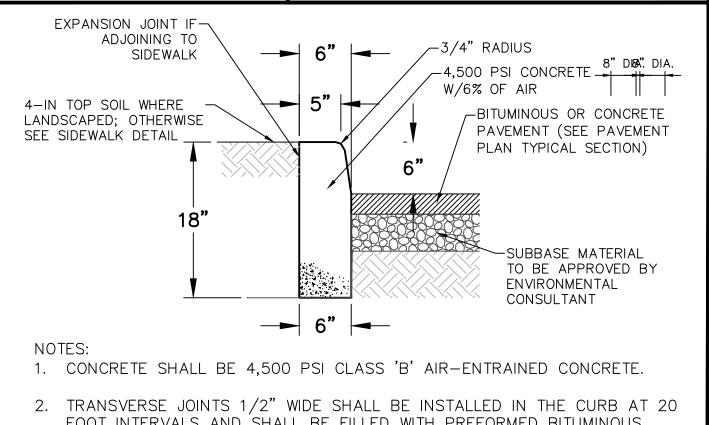

FOOT INTERVALS AND SHALL BE FILLED WITH PREFORMED BITUMINOUS

3. ALL CURBS SHALL BE INSTALLED ON AN APPROVED, COMPACTED SUBGRADE. WHERE DIRECTED BY THE GEOTECHNICAL ENGINEER, A MINIMUM OF FOUR INCHES OF NYSDOT TYPE 4 STONE SHALL BE INSTALLED AS THE

NOTES: 1. CONCRETE TO TEST 4,000 P.S.I. MINIMUM ON 28 DAY TEST. AIR ENTRAINMENT 4% TO 7%, SLUMP TO BE 3" MAXIMUM.

SURFACE

2. TRANSVERSE JOINTS 1/2" WIDE SHALL BE INSTALLED IN THE CURB 20'-0" APART AND SHALL BE FILLED WITH PREFORMED BITUMINOUS 3. EXPOSED CONCRETE SURFACE IS TO BE RUBBED TO PROVIDE SMOOTH FINISHED SURFACE.

FLUSH CONCRETE CURB

UNDISTURBED SOIL

COMPACTED

SUBGRADE

MATERIAL

PARKING STRIPING

4" WIDE PAINTED

STRIPES (WHITE)

TIE INTO EXISTING GROUND └─ 6" MIN. SUBBASE, WHERE REQUIRED (SEE NOTE 9) SEE PAVEMENT ----RECONSTRUCTION OPTIONS A AND B ON THIS SHEET

REF.: NYSDOT PEDESTRIAN FACILITIES 9 OF 12, ISSUED UNDER EI 20-005 - 608-01

ENVIRONMENTAL CONSULTANT -SUBGRADE MATERIAL COMPACTED TO 95% MAXIMUM DRY DENSITY AS DETERMINED BY ASTM 1557 (MODIFIED PROCTOR) AND ACHIEVING MINIMUM 20

1. ALL CONCRETE PAVEMENT AREAS SHALL BE PROOFROLLED TO THE GEOTECHNICAL ENGINEER'S SATISFACTION, WITH AT LEAST 4 PASSES OF EITHER A SMOOTH ROLLER HAVING A MINIMUM STATIC DRUM WEIGHT OF 5-TONS OR A FULLY LOADED TANDEM DUMP. ANY SOFT AREAS SHALL BE REMOVED AND REPLACED WITH CLEAN, GRANULAR, FREE-DRAINING SOIL. FILL SHALL BE PLACED IN LOOSE LIFTS NOT TO EXCEED 12-INCHES AND SHALL BE COMPACTED TO AT LEAST 95% OF ITS MAXIMUM DRY


PRIOR TO INSTALLATION OF PAVEMENT, THE SUBBASE SHALL BE PROOF ROLLED TO THE GEOTECHNICAL ENGINEER'S SATISFACTION. SOFT OR UNSTABLE AREAS SHALL BE REMEDIATED AS

3. TRANSVERSE AND LONGITUDINAL CONTROL JOINTS SHALL BE SAW CUT AT 15 FT MAXIMUM SPACING.

4. DOWEL BARS SHALL BE PLACED AT ALL CONSTRUCTION JOINTS.

OTE: CONTRACTOR SHALL SUBMIT SHOP DRAWINGS SIGNED AND SEALED BY AN ENGINEER LICENSED IN THE STATE OF NEW YORK PRIOR TO CONTRUCTION. RETAINING WALL SECTION CONCRETE PAVEMENT SECTION

CONCRETE

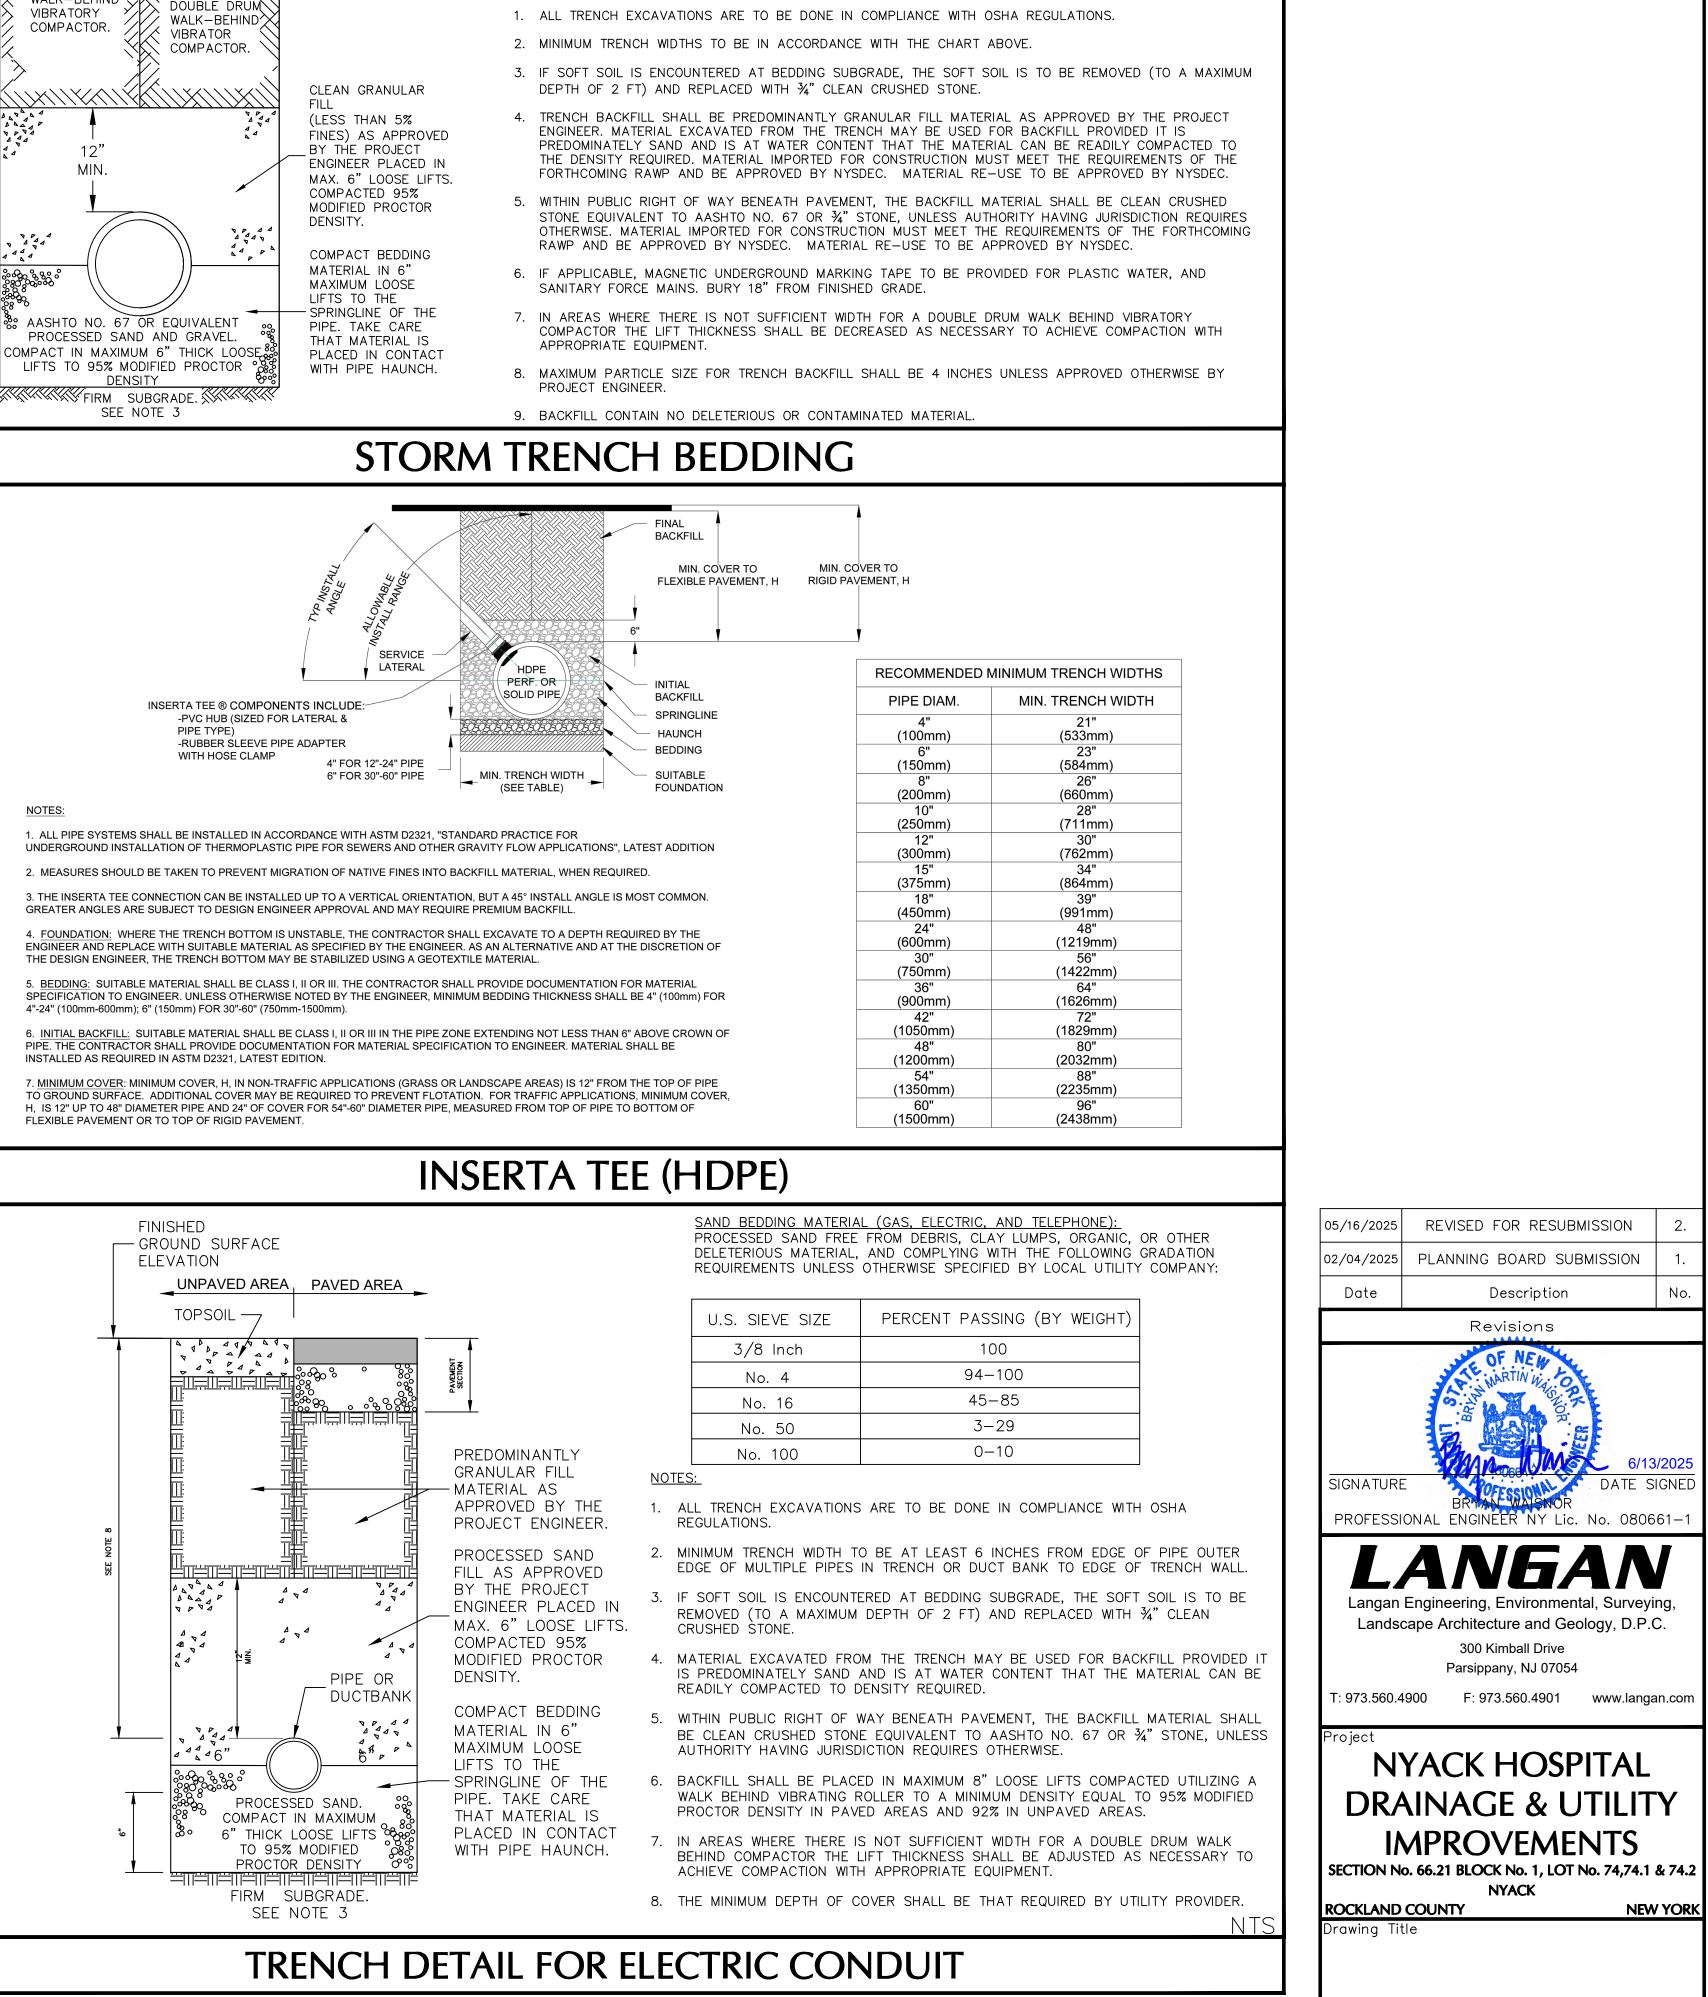

CONTRACTOR TO PROVIDE POLYETHYLENE ENCASEMENT (SLEEVE)

ON ALL CAST IRON AND DUCTILE IRON PIPES CONFORMING TO THE

FOLLOWING REQUIREMENTS OF ASTM D1248. STANDARD

SPECIFICATION FOR POLYETHYLENE PLASTIC MOLDING AND

1. MAXIMUM TRENCH WIDTH "W" TAKEN AT TOP OF PIPE.

EXTRUSION MATERIALS.

MINIMUM TRENCH WIDTH

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THIS DETAIL SHALL BE FOLLOWED

EXCEPT WHERE OTHERWISE REQUIRED

BY UTILITY PROVIDER OR

GEOTECHNICAL ENGINEER

ึ่งใPAVEMENT

SECTION

UNPAVED AREA PAVED AREA

^\Y/\\\Y/\\

PLACE IN

MAXIMUM 8"

LOOSE LIFT

DENSITY

EQUAL TO

PROCTOR

UTILIZING A

DENSITY

AND COMPACT

95% MODIFIED

TO A MINIMUM

FINISHED ELEVATION

PLACE IN MAX

LIFTS TO 92% XX

8" LOOSE

MODIFIED

PROCTOR

COMPACTED

DOUBLE DRUM

WALK-BEHIND


DENSITY


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USING.

ACKFILL

√ARIES¥



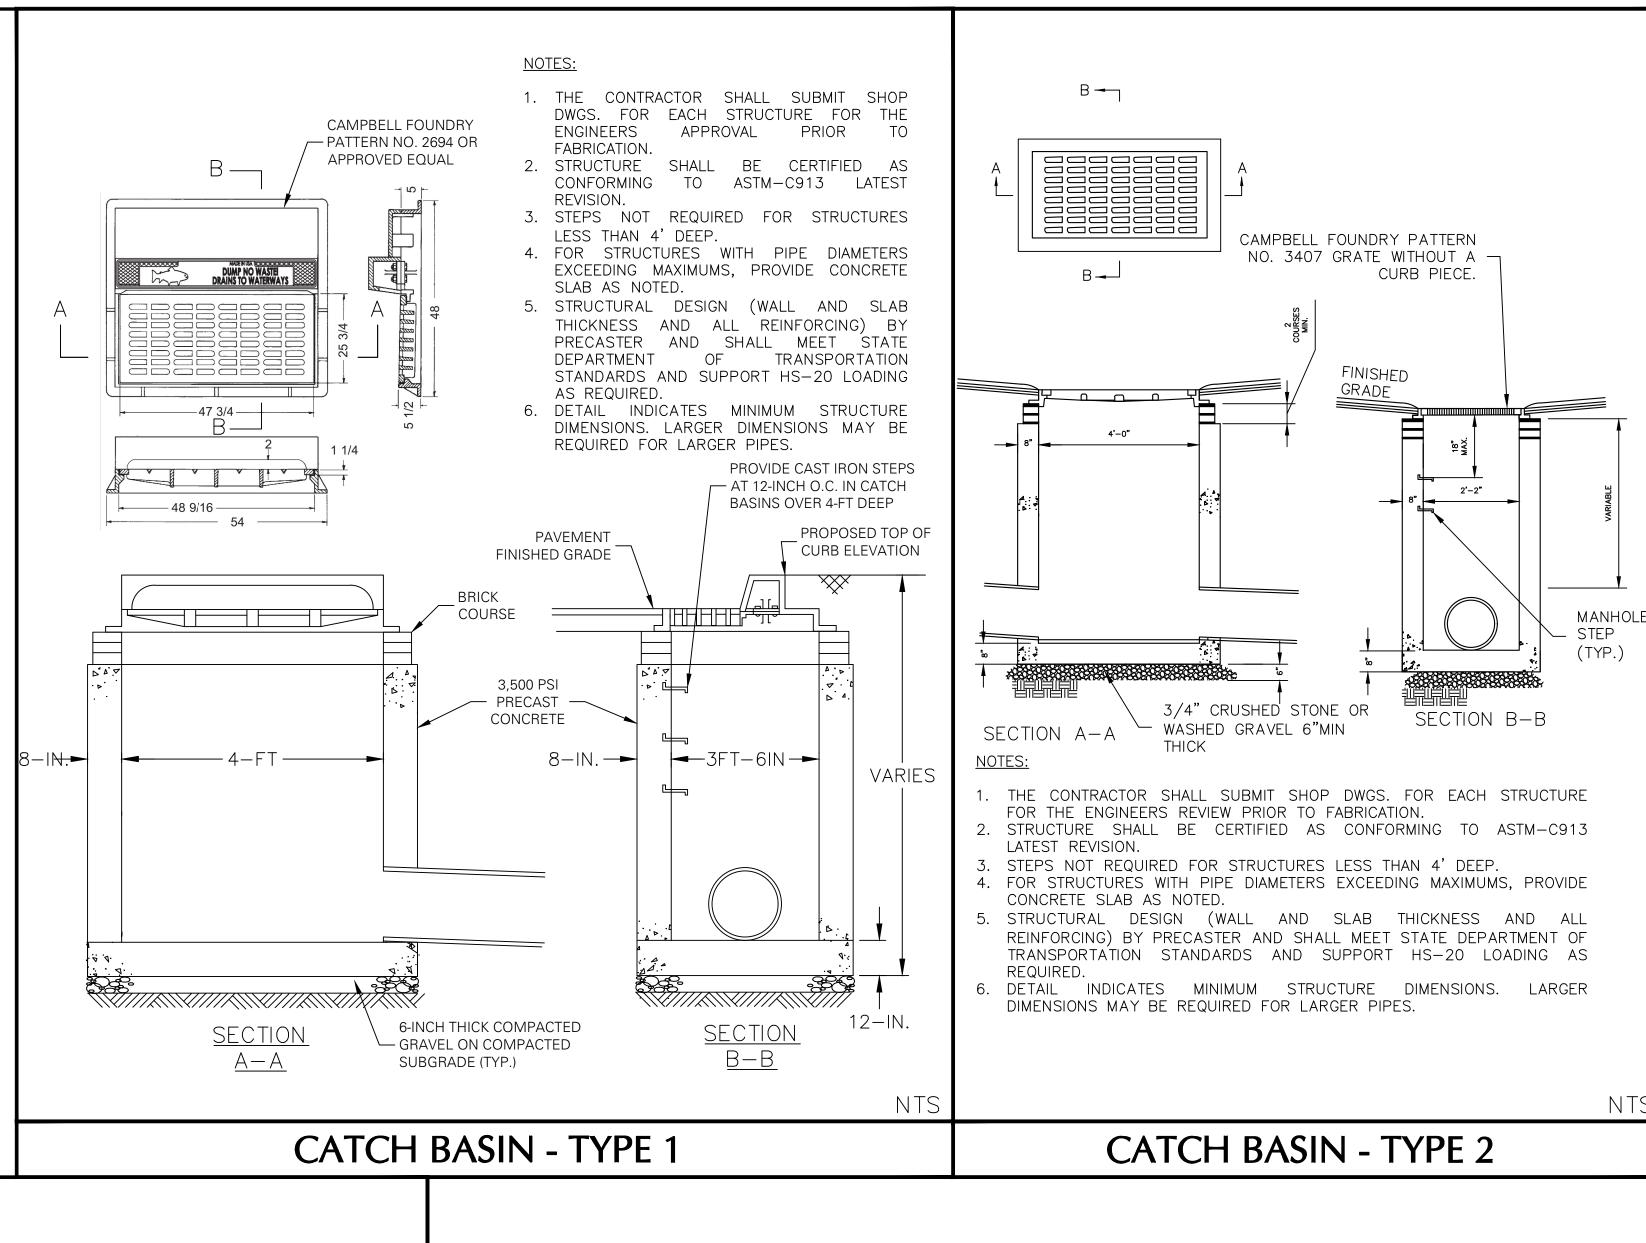

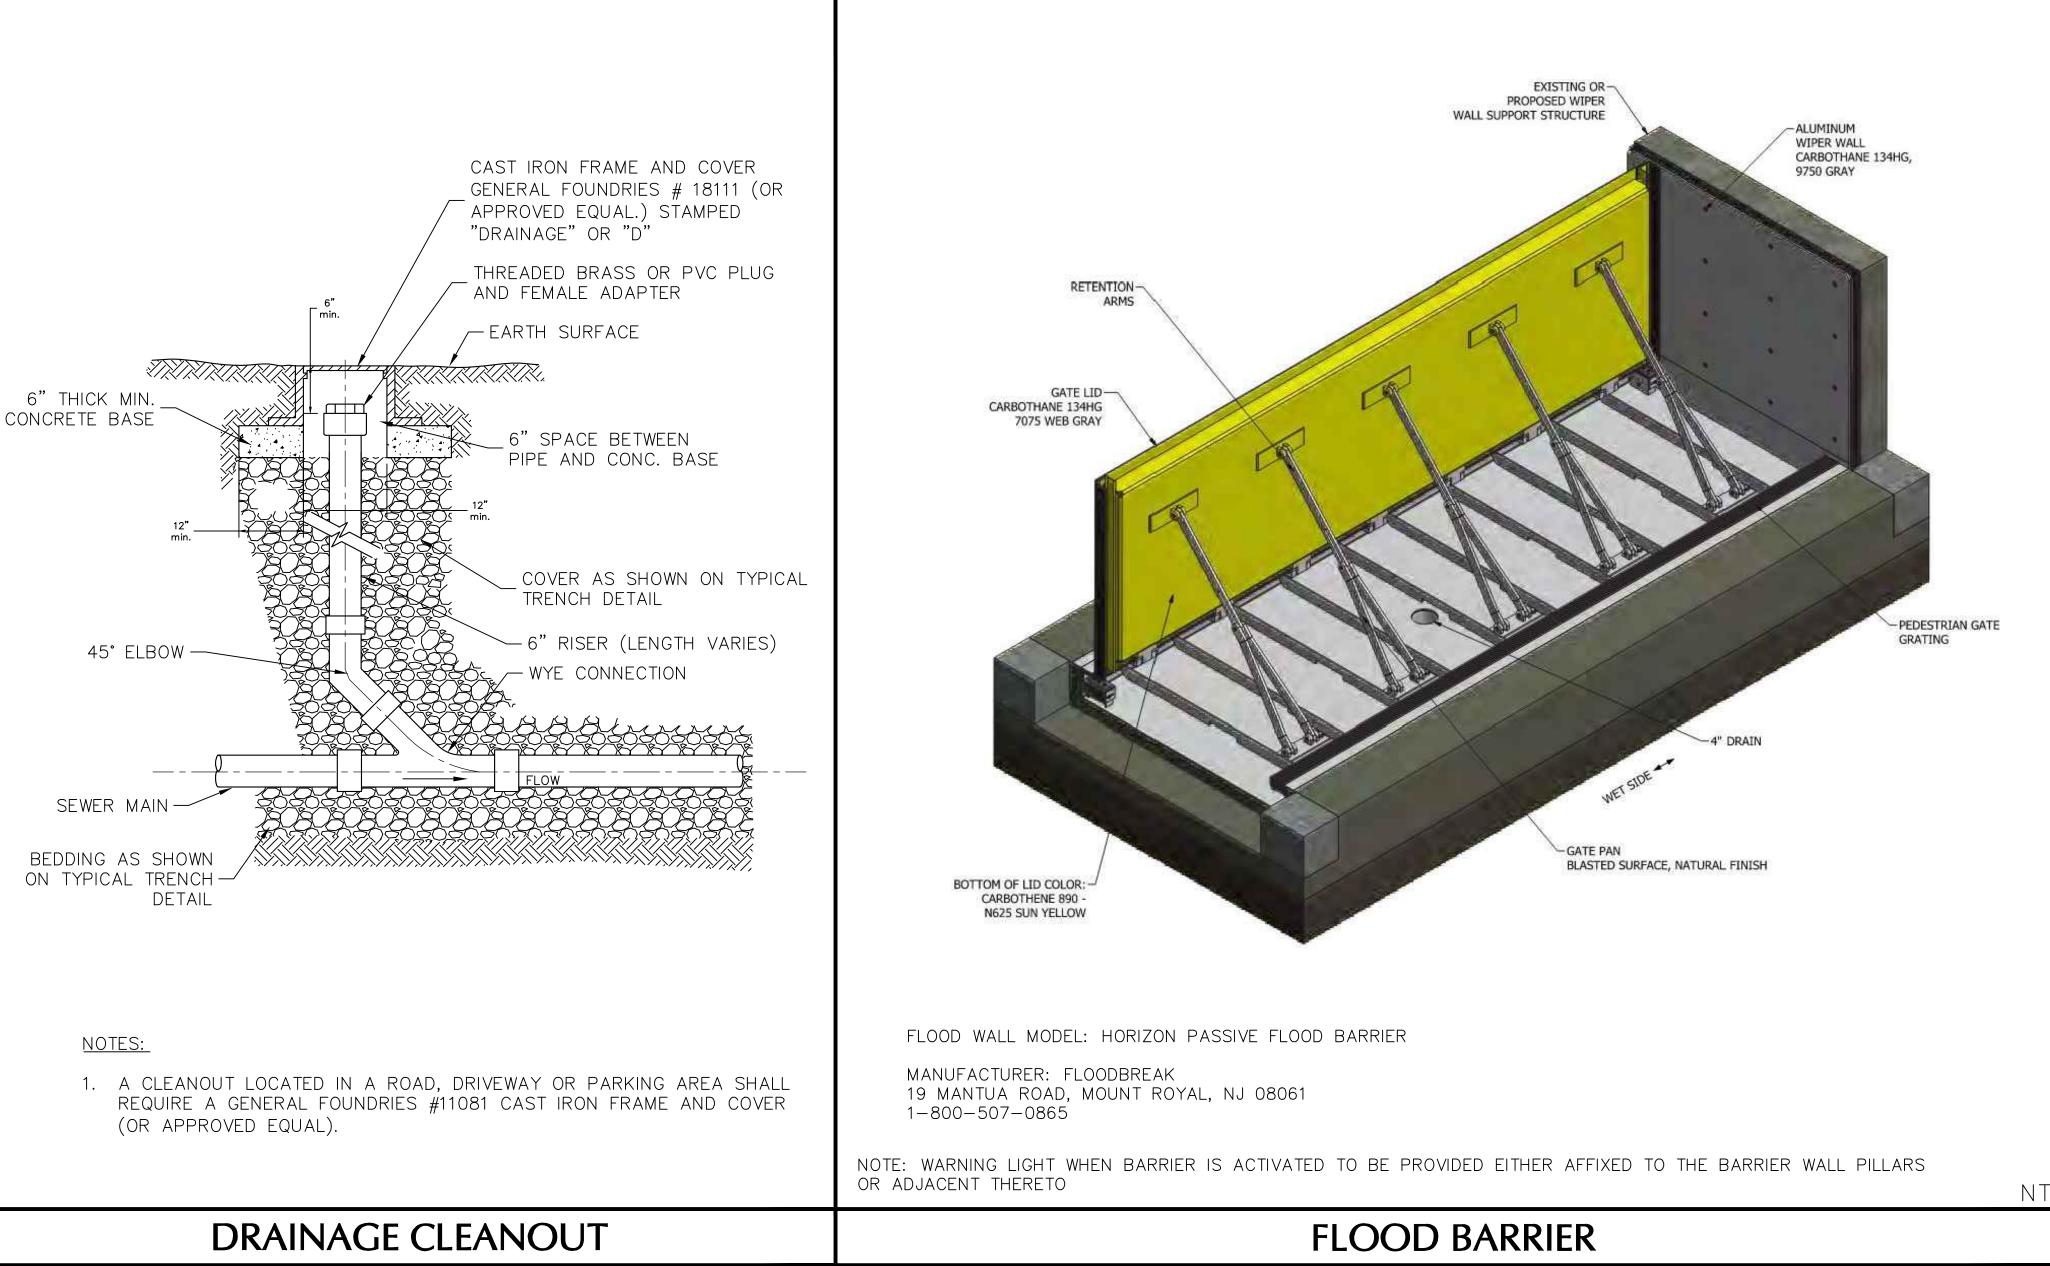**DETAILS II** 

100754212 CS502 1/29/2025 Drawn By

Checked By