## SHEET NOTES:

FIREWALLS.

BATHROOMS.

- 1. PRIME ALL EXTERIOR WALL AND CEILING SURFACES WITH BENJAMIN MOORE 'VAPOR BARRIER PRIMER SEALER 260'
- 2. SISTER IN NEW 2x8 JOISTS ALONG EXISTING 2x8 FLOOR JOISTS ABOVE. INSTALL SOUND INSULATION AND FINISH WITH NEW  $\frac{1}{2}$ " GYPSUM BOARD CEILING. TYPICAL UNDER EXISTING SECOND FLOOR TO REMAIN..
- 3. INFILL OPENING IN EXISTING WALL WITH NEW CMU MASONRY TO MATCH. FINISH EXTERIOR WITH NEW 3-COAT CEMENT STUCCO. GROUT IN 12" #4 DOWELS AT 24"OC.
- 4. INSTALL CONTINUOUS OAK GRIP RAIL AT WALL PER 2020 RCNYS. INSTALL GUARDRAILS
- AND HANDRAILS THROUGHOUT TO COMPLY WITH THE BCNYS.
- 5. INSTALL NEW 36" WIDE STAIR WITH OAK TREADS AND PAINT GRADE RISERS.
  6. INSTALL ½" CEMENT BACKER BOARD FULL HEIGHT AT SHOWER AND BATHTUB WALLS.
- 7. INSTALL  $\frac{1}{2}$ " 'HUMITEK' MOLD RESISTANT GYPSUM BOARD AT ALL BATHROOM WALLS OUTSIDE OF SHOWERS & TUBS. INSTALL OVER FIRE RATED GYPSUM BOARD AT
- 8. INSTALL NEW 2x6 BLOCKING IN WALLS AT 48" AFF FOR ACCESSORIES. TYPICAL AT
- 9. INSTALL ROD & SHELF AT CLOSET. TYPICAL.
- 10. APPLY NEW 3-COAT CEMENT STUCCO ON EXPANDED GALVANIZED METAL LATH OVER EXISTING EXTERIOR BRICK OR MASONRY WALLS. REFER TO DETAIL A/A6.
- 11. ROLL-IN ACCESSIBLE CERAMIC TILE FINISHED SHOWER WITH SHOWER CURTAIN. PITCH FLOOR TO DRAIN TO SHOWER DRAIN.
- 12. INSTALL SHOWER CURTAIN AND ROD AT BATHTUBS. TYPICAL.
- 13. TRIM OUT ALL WINDOWS WITH 3" TRIM AS CHOSEN BY OWNER. PAINT FINISH.
- 14. EXISTING MASONRY CHIMNEY TO REMAIN.

TYPICAL AT NEW EXTERIOR STUD WALLS.

DIRECTLY TO THE EXTERIOR. TYPICAL.

- 15. INSTALL UTILITY HOOKUP AT LAUNDRY CLOSET. PROVIDE AND INSTALL 4" GALVANIZED DRYER VENT DUCTED DIRECTLY TO EXTERIOR. DO NOT INSTALL FLEX DUCT.
- 16. NEW 4"x4" STEEL COLUMN ON 8"x8"x1/2" STEEL BASE PLATE ON NEW 36" SQUARE
- 17. NEW 36"x36" BILCO TYPE 'E' OR EQUAL ROOF HATCH ABOVE. PROVIDE STEEL LADDER


WITH GRAB POLE, BOLTED TO WALL TO ACCESS ROOF HATCH.

- 18. NEW 2x6 STUD WALL OVER EXISTING CMU WALL BELOW. SHEATH EXTERIOR WITH  $\frac{1}{2}$ " CDX PLYWOOD AND INSULATE BETWEEN STUDS WITH HIGH DENSITY R-21 BATTS..
- 19. ROOF DRAIN FROM ABOVE. DRAIN TO GO UNDER NEW SLAB AND CONNECT TO CATCH BASIN AT STREET. REFER TO SITE PLAN.
- 20. INSTALL ALUMINUM CAP FLASHING AND DRIP EDGE AT ROOF TOP. SEE DETAIL B/A6.
- 21. ½" CDX PLYWOOD OVER 2x4 STUD WALL TO SUPPORT ROOF RAFTERS. RUN EDPM ROOFING MEMBRANE UP SIDE WALL. SEE DETAIL B/A6.
- 22. INSTALL EDPM ROOFING MEMBRANE OVER TAPERED RIGID INSULATION. PITCH INSULATION TO ROOF DRAINS. MINIMUM ROOF INSULATION THICKNESS TO BE 2" /R-10. INSTALL OVER  $\frac{3}{4}$ " CDX PLYWOOD DECKING.
- 23. SLOPED ROOF PERIMETER SCREEN AROUND FLAT MECHANICAL AREA. INSTALL 'LIFETIME' ARCHITECTURAL ROOF SHINGLES OVER 30# ROOFING FELT ON ½" PLYWOOD
- SHEATHING OVER 2x6 RAFTERS AT 16"OC. SEE DETAIL B/A6.

  24. INSTALL NEW FIXTURES & CABINETS AT EXISTING KITCHENS AND BATHROOMS AS
- 25. INSTALL EXHAUST HOOD WITH CHARCOAL FILTER OVER NEW STOVE AND VENT
- 26. NEW HARDIE SHINGLE STRAIGHT EDGE SIDING AT 6"TW OVER ¾" /R-5 FOIL FACED POLYSIO CONTINUOUS EXTERIOR INSULATION. TAPE ALL SEAMS IN THE EXTERIOR
- 27. DROP CEILING TO 7'-10" TO CREATE A MECHANICAL/ HVAC SOFFIT SPACE. SEE DETAIL


INSULATION WITH MANUFACTURERS SPECIFIED FOIL FACED TAPE.

- 28. CLOSE UP EXISTING OPENINGS AS REQUIRED TO MATCH ADJOINING FRAMING OR MASONRY. INSTALL NEW SIDING OVER ¾" / R-5 FOIL FACED POLYISO CONTINUOUS EXTERIOR INSULATION. REFER TO ELEVATIONS.
- 29. INSTALL NEW HARDIE PLANK SMOOTH LAP SIDING AT 5" TW OVER  $\frac{3}{4}$ " / R-5 FOIL FACED POLYISO CONTINUOUS EXTERIOR INSULATION. TAPE ALL SEAMS IN THE EXTERIOR INSULATION WITH MANUFACTURERS SPECIFIED FOIL FACED TAPE.
- 30. SET ROOFTOP HVAC UNITS ON INSULATED CURB. CURB INSULATION TO BE MINIMUM R-8. REFER TO MANUFACTURER FOR DIMENSIONS AND DETAILS.
- 31. INSULATE UNDER STAIR WITH MINIMUM R21 INSULATION AND FINISH WITH 1 LAYER  $\frac{5}{8}$ " TYPE 'X' FIRE CODE GYPSUM BOARD.
- 32. 6" ROOF DRAIN WITH GRATED CAP. COUNTER-FLASH TO ROOFING AS REQUIRED BY EDPM MANUFACTURER.
- 33. SURFACE MOUNTED ALUMINUM MAILBOXES FOR EACH APARTMENT. MAILBOXES TO MEET USPS SPECIFICATIONS FOR SIZE & ACCESS.
- 34. RELOCATE ELECTRIC SERVICE AND ELECTRIC METERS TO NEW REAR STAIR WALL.
- 35. INSTALL NEW FIRE AND SMOKE DETECTION SYSTEM AND CONNECT TO CENTRAL STATION.
- 36. INSTALL NEW FIRE SPRINKLER SYSTEM. SYSTEM TO BE DESIGNED BY AN ENGINEER AS REQUIRED BY THE NEW YORK STATE BUILDING CODE.

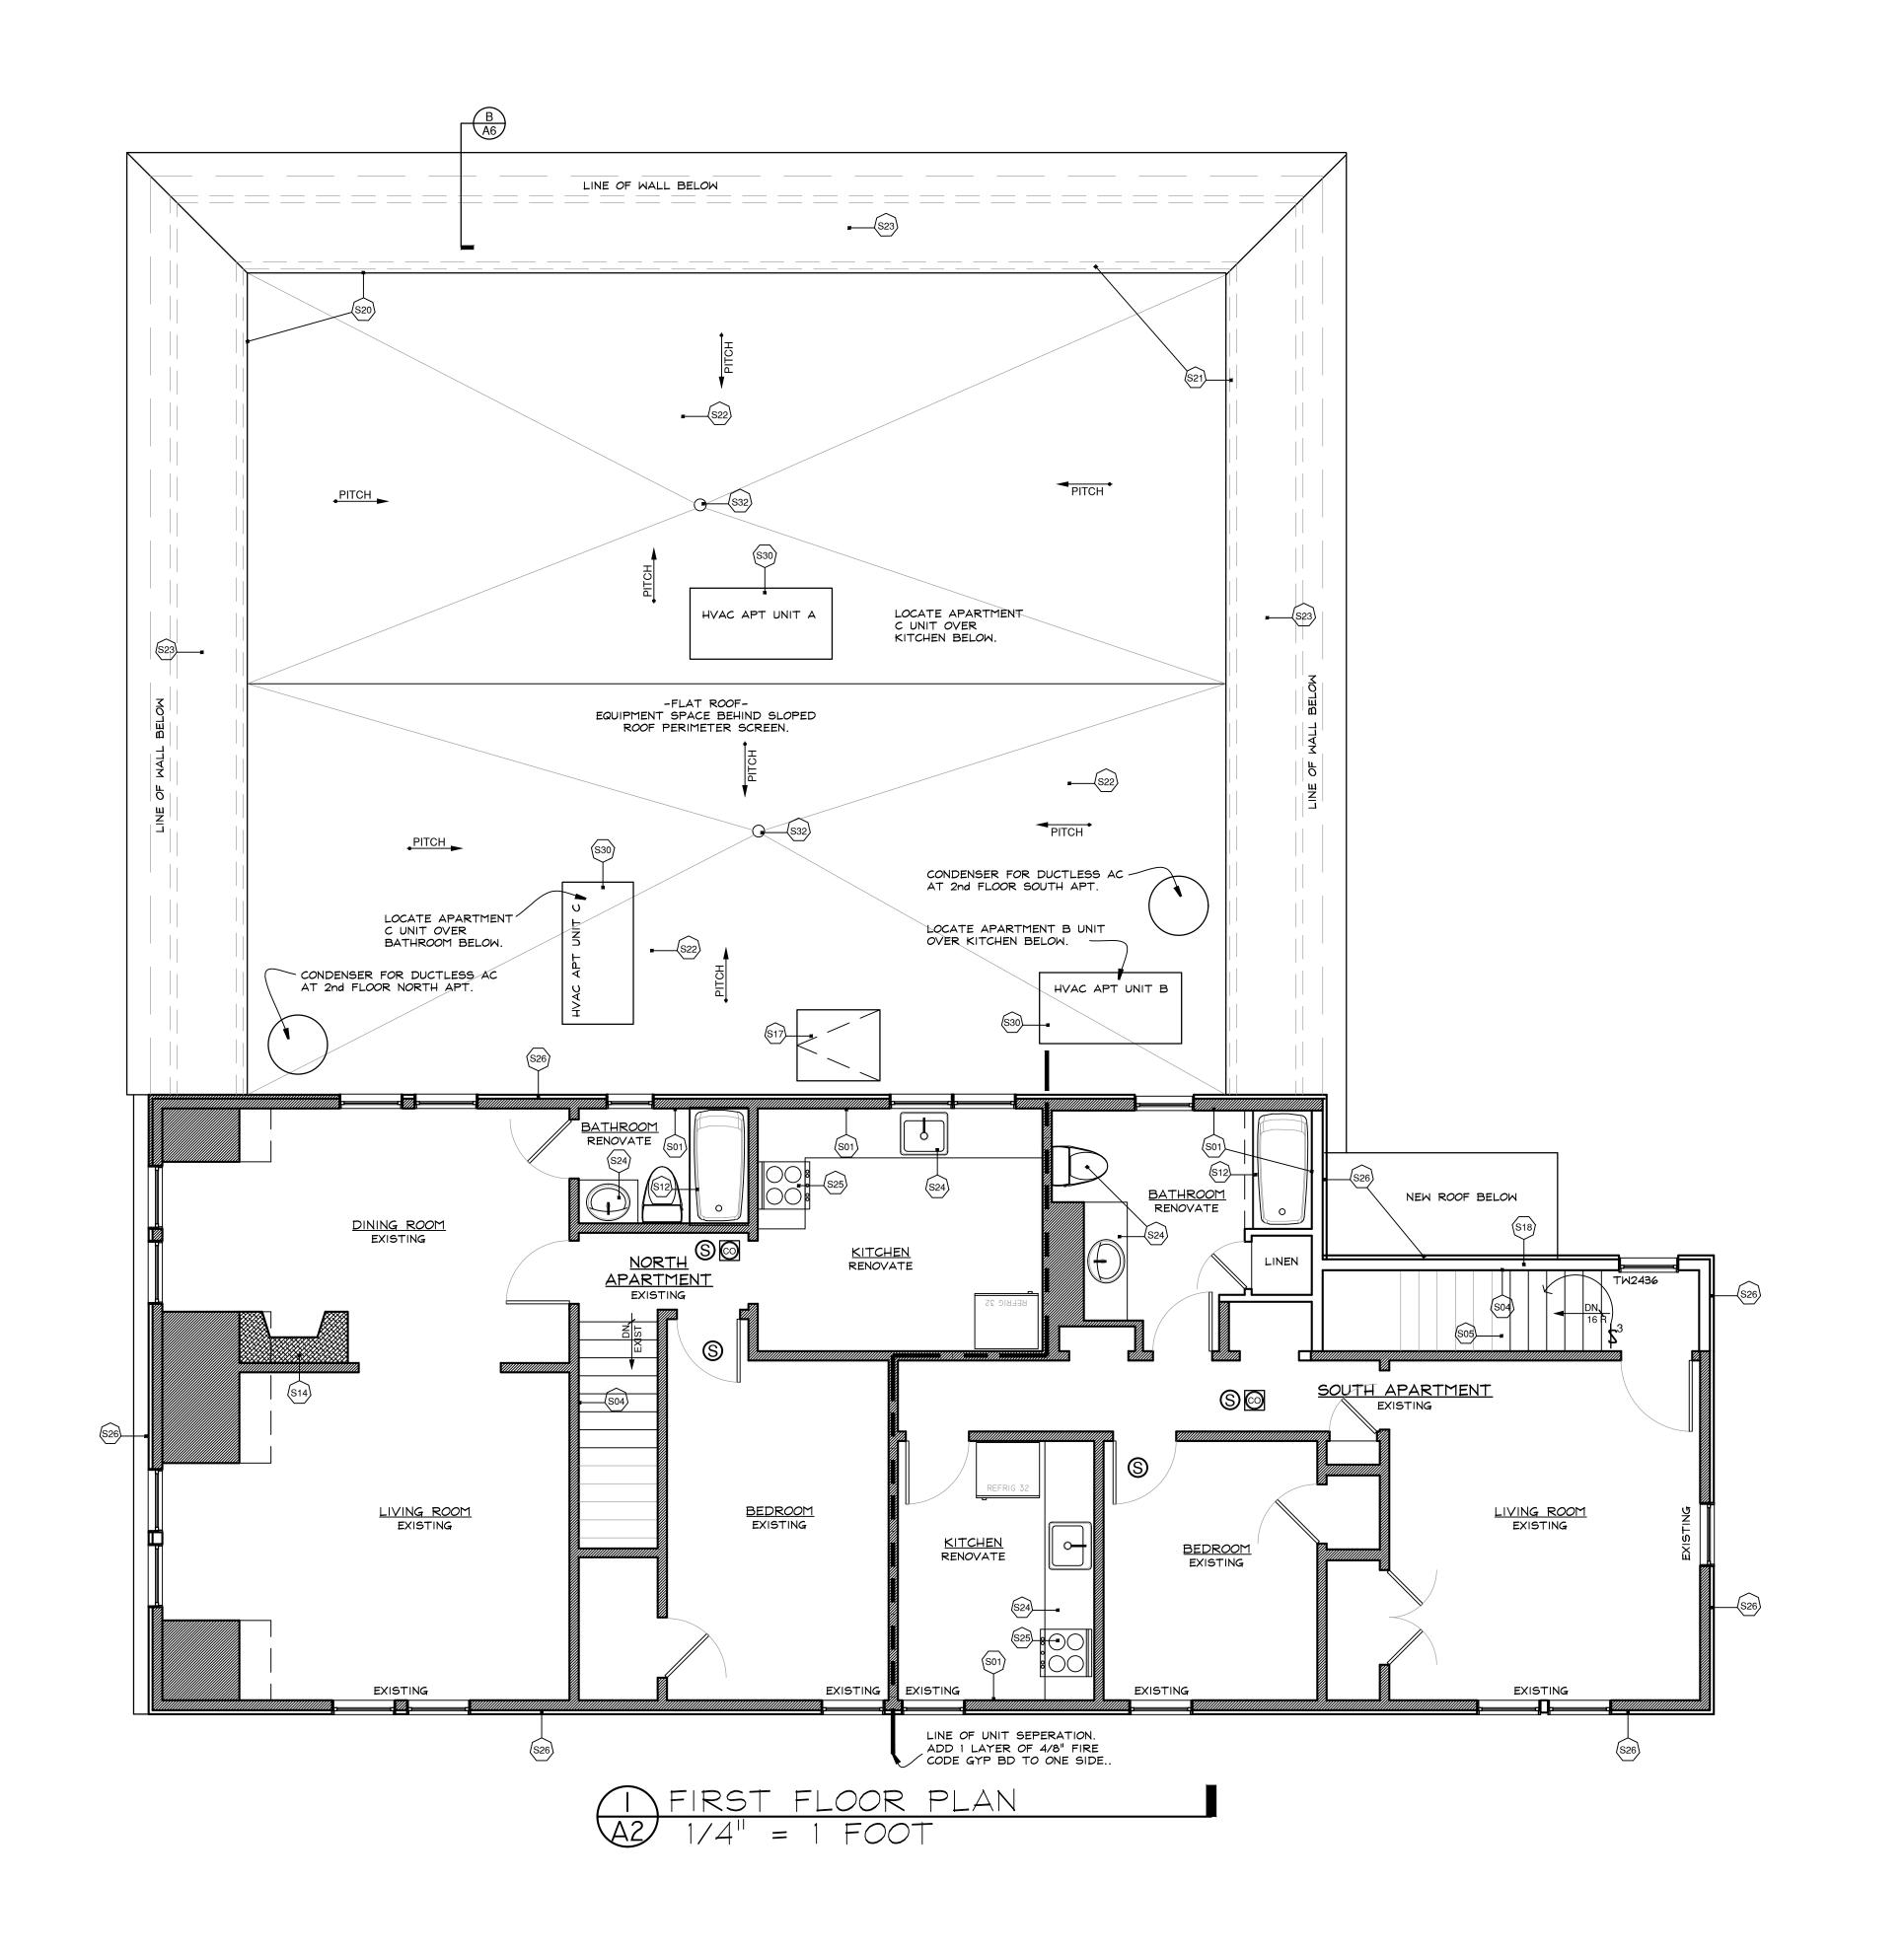

## GENERAL NOTES

- 1. **DO NOT SCALE THE DRAWINGS.** USE INDICATED DIMENSIONS ONLY.
- 2. ALL WORK SHALL CONFORM TO LOCAL AND 2020 BUILDING CODE OF NEW YORK STATE REQUIREMENTS. NO WORK SHALL COMMENCE UNTIL A BUILDING PERMIT HAS BEEN ISSUED AS REQUIRED BY THE LOCAL BUILDING DEPARTMENT.
- 3. ALL DIMENSIONS ARE TO FACE OF STUD UNLESS OTHERWISE INDICATED. DOOR SIZES ARE IN FEET-INCHES.
- 4. ALL PENETRATIONS THROUGH CEILINGS AND EXTERIOR WALLS SHALL BE AIR SEALED WITH EXPANDING FOAM AND/OR SILICONE CAULK PRIOR TO FLASHING
- 5. NEW WINDOWS ARE 400 SERIES BY ANDERSEN. UNITS TO BE LOW-E COATED WITH INSULATING GLASS AND ARGON GAS. PROVIDE ALL OPERATING UNITS WITH SCREENS. UNIT NUMBERS ARE INDICATED ON THE PLANS.
- 6. ALL WOOD IN CONTACT WITH MASONRY & CONCRETE SHALL BE PRESSURE TREATED WITH A WOOD PRESERVATIVE.
- 7. INSTALL HANGERS AND CONNECTORS BY SIMPSON STRONG-TIE (SST) AS NOTED ON THE DRAWINGS AND DETAILS. INSTALL ALL CONNECTORS WITH NAILS OR SCREWS AS SPECIFIED BY SIMPSON STRONG-TIE. DO NOT SUBSTITUTE CONNECTORS OR FASTENERS. ALL FASTENER COATINGS SHALL MATCH THE EXTERIOR COATING OF THE SPECIFIED HANGER: HDG TO HDG AND STAINLESS TO STAINLESS.
- 8. FLASH ALL WINDOW ROUGH OPENINGS WITH A PEEL & STICK TYPE MEMBRANE FLASHING. FLASH SILLS TO CREATE A DRAIN PAN PITCHED TO THE EXTERIOR SIDE.
- 9. SEAL AROUND ALL DOOR AND WINDOW ROUGH OPENINGS WITH MINIMALLY EXPANDING FOAM. FOLLOW MANUFACTURERS PRECAUTIONS
- 10. ANY EXISTING EXTERIOR WALL CAVITY THAT IS OPENED SHALLBE FILLED TO THE FULL DEPTH OF THE CAVITY WITH HIGH DENSITY FIBERGLASS INSULATION. TYPICAL.
- 11. REFER TO THE SPECIFICATIONS FOR ADDITIONAL INFORMATION.

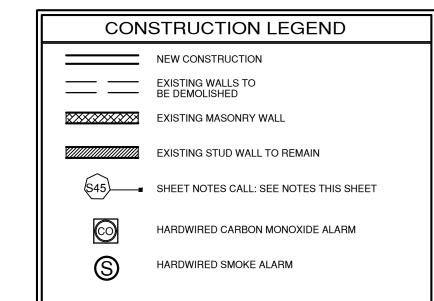



SBL: 60.77-2-61


N Midland Apartments 245 N. Midland Avenue Nyack, N.Y. 10960

KIER B. LEVESQUE, R.A. ARCHITECT

49 THIRD AVENUE NYACK, NEW YORK 10960 845-358-2359

SECOND FLOOR & ROOF PLAN

SCALE AS SHOWN
DATE FEBRUARY 18, 2016
JOB NO. 1584
REVISIONS: SHEET NO.

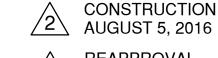

REAPPROVAL JULY 14, 2022

**A**-3